

- WRAP WITH DUCT TAPE OVER INSULATION

JACKET MIN. 4" OUT

FROM BRANCH DUCT

~INSULATION

←1" STEEL BAND CLAMP

WITH WIRE HANGER

OPTIONAL

LDUCT CLAMP

COLLAR

—FLEX DUCT

LOCKING

WING —

#### **EXHAUST FAN SCHEDULE** GENERAL ELECTRICAL DAMPER ESP. MOTOR CONTROLS **NOTES EQUIPMENT** LOCATION | AREA SERVED | MANUFACTURER | MODEL **FAN TYPE** SONES CFM DRIVE MCA | MOCP | PHASE | VOLTS SIZE (INCHES) | WATTS | RPM | TAG INTERLOCK WITH RELAY PER STORAGE & FORWARD CURVED 185 DIRECT CE)LING GC-186 8''Ø 0.50 86.6 | 1100 | 1.44 | 15 LOREN COOK ELECTRICAL DRAWINGS KITCHENETTE INLINE MEN'S & FORWARD CURVED INTERLOCK WITH RELAY PER GC-542 10"Ø 300 DIRECT 109 | 1600 | 1.82 | 15 TEF-1 LOREN COOK 0.50 ,2,3,4,5,6 CEILING WOMEN'S ELECTRICAL DRAWINGS 1. SINGLE POINT WIRING CONNECTION 4. EXHAUST TERMINATION SHALL BE AT LEAST 10'-0" ABOVE GRADE 2) EXHAUST TERMINATION SHALL BE AT LEAST 2'-0" ABOVE OR 10'-0" FROM ANY O.A.I. OPENING 5. PROVIDE GRAVITY BACKDRAFT DAMPER

DOOMANA NA NA F	OCCUPANCY	AREA	# OF	AIR DISTRIBUTION	ORDINAN	CE REQUIRED	ACTUA	L MINIMUM P	ROVIDED	EQUIPME	NT SERVING	DEN 4 A DIVO
ROOM NAME	TYPE	(SQ.FT.)	PEOPLE	<b>EFFECTIVENESS</b>	O.A.I. CFM	EXHAUST CFM	SUPPLY CFM	O.A.I. CFM	EXHAUST CFM	SUPPLY FAN	EXHAUST FAN	REMARKS
RECEPTION 101	RECEPTION	144	4	0.8	38	N.R.	210	52.5	0	F-4A	N/A	
CONF #1 102	CONFERENCE	155	8	0.8	60	N.R.	240	60	0	F-4A	N/A	
OFFICE #1 103	OFFICE	95	1	0.8	13	N.R.	145	36.25	0	F-4A	N/A	
TEAM ROOM 104	OFFICE	132	1	0.8	14	N.R.	200	50	0	F-4A	N/A	
OFFICE #2 105	OFFICE	33	1	0.8	9	N.R.	50	12.5	0	F-4A	N/A	
NORK STATIONS 406	OFFICE	170	1	0.8	18	N.R.	235	58.75	0	F-4A	N/A	
WORK STATIONS 106	OFFICE	770	4	0.8	82	N.R.	780	195	0	F-4B	N/A	
KITCHENETTE 107	KITCHEN	142	N/A	0.5	N.R.	99	150	37.5	110	F-4B	EF-1	INTERMITTENT EXHAUST
STORAGE #1 108	STORAGE	35	N/A	N/A	N.R.	N.R.	0	0	75	N/A	EF-1	
STORAGE #2 109	STORAGE	21	N/A	N/A	N.R.	N.R.	30	7.5	0	F-4B	N/A	
MAIL 110	OFFICE	69	1	0.8	11	N.R.	80	20	0	F-4B	N/A	
MEN'S 111	TOILET (PUBLIC)	46	N/A	0.8	N.R.	70	40	10	150	F-4B	TEF-1	HEAVY USE
WOMEN'S 112	TOILET (PUBLIC)	77	N/A	0.8	N.R.	70	50	12.5	150	F-4B	TEF-1	HEAVY USE
CONF #2 113	CONFERENCE	77	4	0.8	30	N.R.	120	30	0	F-4A	N/A	
CORRIDOR	CORRIDOR	168	N/A	0.8	13	N.R.	70	17.5	0	F-4B	N/A	
TOTAL		2134	24		288	239	2400	600	485			

6. PROVIDE UNIT MOUNTED DISCONNECT

2. CONTRACTOR SHALL DETERMINE BORDER TYPE

BRANCH -

DIFFUSER, GRILLE, AND REGISTER SCHEDULE													
EQUIPMENT TAG	MANUFACTURER	MODEL	ODEL TYPE SERVICE TYPE		MATERIAL	MAXIMUM NOISE CRITERIA	NOTES						
SA	TITUS	OMNI	24"x24" SQUARE PLAQUE DIFFUSER	SUPPLY	STEEL	25	1,2						
SB	TITUS	OMNI	12"x12" SQUARE PLAQUE DIFFUSER	SUPPLY	STEEL	25	1,2						
RA	TITUS	50F	24"x24" EGG CRATE GRILLE	RETURN	ALUMINUM	25	2						
RB	TITUS	350ZRL	0 DEGREE LOUVERED GRILLE	RETURN	STEEL	25	1,2						
EA	TITUS	350RL	12"x12" 35 DEGREE LOUVERED GRILLE	EXHAUST	STEEL	25	1,2						
<u>NOTES</u>													

DIFFUSERS, GRILLES, AND REGISTERS ABOVE HARD CEILING MUST HAVE EXTERNALLY ACCESSIBLE ADJUSTABLE VOLUME DAMPERS

✓ MIN. 4" COLLAR

— MAX 2"FROM

BRANCH DUCT

1" STEEL —

NO SCALE

COLLAR

—FLEX DUCT

FLEXIBLE TO RIGID DUCT CONNECTION DETAILS

STRAP HANGER

BAND OR

HANGER

THERMACLIP

AND SADDLE-STRAP

1" MINIMUM STEEL BAND HANGER OR THERMACLIP AND SADDLE-

─WIRE HANGER

—————————1" MINIMUM

FLEX DUCT & COLLAR

## MECHANICAL GENERAL NOTES

- ALL EQUIPMENT AND COMPONENTS FOR HEATING, VENTILATING, AND AIR CONDITIONING SYSTEMS SHALL COMPLY AND BE INSTALLED FOR THE EFFICIENT UTILIZATION OF ENERGY IN ACCORDANCE WITH LOCAL
- ALL MECHANICAL EQUIPMENT SHALL BEAR THE LABEL OF AN APPROVED AGENCY, AND SHALL BE INSTALLED IN ACCORDANCE WITH THE INFORMATION ON THE LABEL AND PER THE MANUFACTURER'S RECOMMENDATIONS. THE MECHANICAL CONTRACTOR SHALL MAINTAIN THE MANUFACTURER'S INSTALLATION INSTRUCTIONS FOR ALL MECHANICAL EQUIPMENT AT THE JOB SITE. THE MECHANICAL EQUIPMENT SPECIFIED SHALL MEET ALL APPLICABLE STANDARDS INCLUDING THE INTERNATIONAL MECHANICAL CODE, SMACNA, ASHRAE, AND THE INTERNATIONAL FUEL GAS CODE WHERE IT APPLIES.
- THE CONSTRUCTION OF ALL DUCTWORK MUST BE IN ACCORDANCE WITH THE LATEST SMACNA DUCT CONSTRUCTION STANDARDS - METAL AND FLEXIBLE. COVERINGS AND LININGS, INCLUDING ADHESIVES, SHALL HAVE A FLAME-SPREAD INDEX NO MORE THAN 25 AND A SMOKE-DEVELOPED INDEX NOT MORE THAN 50. WHEN TESTED IN ACCORDANCE WITH ASTM E 84. DUCT COVERINGS AND LININGS SHALL NOT FLAME, GLOW, SMOLDER OR SMOKE WHEN TESTED IN ACCORDANCE WITH ASTM C 411 AT THE TEMPERATURE TO WHICH THEY ARE EXPOSED IN SERVICE. THE TEST TEMPERATURE SHALL NOT FALL BELOW 250 DEG. F. FLEXIBLE DUCTS AND CONNECTORS SHALL BE TESTED IN ACCORDANCE WITH UL 181 AND BE LABELED. FLEXIBLE CONNECTORS SHALL BE LIMITED TO A MAXIMUM LENGTH OF 10 FEET. DUCTS MUST BE SEALED IN ACCORDANCE WITH THE INTERNATIONAL ENERGY CONSERVATION CODE. RIGID DUCTS MUST BE SUPPORTED AT INTERVALS NOT EXCEEDING 10 FEET. ALL AIR FILTERS SHALL BE LISTED AND
- 4. MECHANICAL CONTRACTOR SHALL FURNISH AND INSTALL FIRE DAMPERS IN DUCTWORK AND FIRESTOP ALL PIPE PENETRATIONS THRU RATED FLOORS, CEILINGS AND WALLS. VERIFY LOCATIONS OF ALL RATED ASSEMBLIES WITH ARCHITECTURAL PLANS. FIRE DAMPERS SHALL BE IN ACCORDANCE WITH UL 555.
- 5. THE MECHANICAL CONTRACTOR SHALL HIRE AN INDEPENDENT AND CERTIFIED TEST AND BALANCE CONTRACTOR, AND SHALL PROVIDE A TEST AND BALANCE REPORT TO BE SENT TO THE BUILDING DEPARTMENT NO LESS THAN THREE DAYS PRIOR TO FINAL INSPECTION.
- 6. PROVIDE LOCKABLE MANUAL BALANCING DAMPERS AT ALL BRANCH TAKE-OFFS TO AIR DEVICES. BRANCH SIZES TO AIR DEVICES SHALL BE SAME AS AIR DEVICE NECK SIZE UNLESS SHOWN OTHERWISE ON PLANS. ALL WORK SHALL BE EXECUTED IN ACCORDANCE WITH THE NATIONAL, STATE AND LOCAL CODES AND REGULATIONS GOVERNING THE INSTALLATION OF THE WORK INVOLVED. ALL PERMITS FOR THE

CONTRACTOR, THE COST OF WHICH SHALL BE INCLUDED IN THEIR BID.

8. ALL CONCEALED RECTANGULAR SUPPLY AND RETURN DUCTWORK SHALL BE WRAPPED WITH 1-1/2" FOIL FACED INSULATION. ALL CONCEALED ROUND SHALL BE WRAPPED WITH 1-1/2" FOIL FACED INSULATION.

INSTALLATION OF THE WORK AND ALL INSPECTIONS OF SAME SHALL BE ARRANGED FOR BY THIS CONTRACTOR. ALL FEES AND ASSESSMENTS IN CONNECTION THEREWITH SHALL BE PAID BY THIS

- . ALL VENTS AND EXHAUSTS SHALL BE LOCATED A MINIMUM OF 10'-0" FROM ANY FRESH AIR INTAKES PER LOCAL CODES. PLUMBING VENTS SHALL BE A MINIMUM OF 10'-0" FROM ANY FRESH AIR INTAKE. EXTEND TERMINATION HEIGHT TO PROVIDE A 10'-0" CROSS SECTION CLEARANCE FROM PLUMBING VENTS WHERE
- 10. COORDINATE DIFFUSER LAYOUT WITH ARCHITECTURAL AND ELECTRICAL REFLECTED CEILING PLANS.
- 11. ALL DUCTWORK TO BE ROUTED AS HIGH AS POSSIBLE, UNLESS NOTED OTHERWISE ON PLANS.
- 12. FLEXIBLE DUCT SHALL BE UTILIZED AS MUCH AS POSSIBLE AS ACCEPTABLE PER CODE, IN UNLIMITED

## MECHANICAL LEGEND

AND RECONDITION AS REQUIRED.

NEW DUCTWORK AND AIR DEVICES TO MATCH EXISTING. EXISTING DUCTWORK AND AIR DEVICES TO REMAIN. CLEAN

EXISTING DUCTWORK AND AIR DEVICES TO BE REMOVED.

THERMOSTAT - TRANE, MTD @ 50"AFF, U.N.O.

SENSOR (REMOTE TEMPERATURE) MTD @ 50"AFF SENSOR (REMOTE HUMIDITY) MTD @ 50"AFF TAKEOFF WITH MANUAL VOLUME DAMPER

LOCKABLE MANUAL VOLUME DAMPER (MVD) FIRE DAMPER

ABOVE FINISHED FLOOR

BELOW FINISHED CEILING

LOCKABLE MANUAL VOLUME DAMPER

UNDER CUT DOOR NEW TO EXISTING CONNECTION

EQUIPMENT TAG

NEW AIR DEVICE TAG


CEILING SUPPLY DIFFUSER

CEILING RETURN AIR DIFFUSER

SUPPLY REGISTER


RETURN / EXHAUST GRILLE

MAXIMUM CFM	ROUND OPTION	SQUARE OPTION	RECTANGULAR OPTION
65	5"ø	6"x6"	6"x4"
120	6"ø	6"x6"	8"x4"
150	7"ø	6"x6"	10"x4"
250	8"ø	8"x8"	10"x6" OR 14"x4"
435	10"ø	10"x8"	14"x6"
710	12"ø	12"x10"	14"x8" OR 20"x6"
1000	14"ø	12"x12"	16"x10" OR 20"x8"
1500	16"ø	14"x14"	20"x10" OR 26"x8"
2000	18"ø	16"x16"	26"x10" OR 32"x8"
3000	22"ø	20"x18"	28"x12" OR 40"x10"

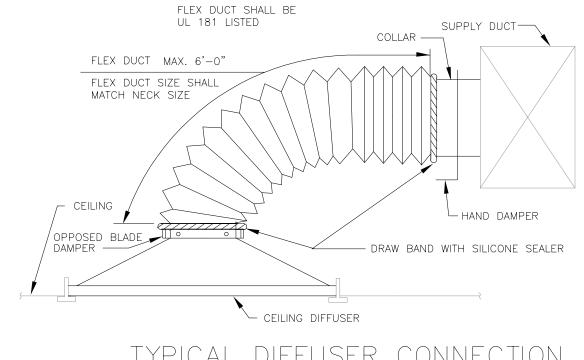

3. PROVIDE WIRE MESH SCREEN


TYPICAL DIFFUSER CONNECTION NO SCALE (SIDE OF DUCT CONNECTION)

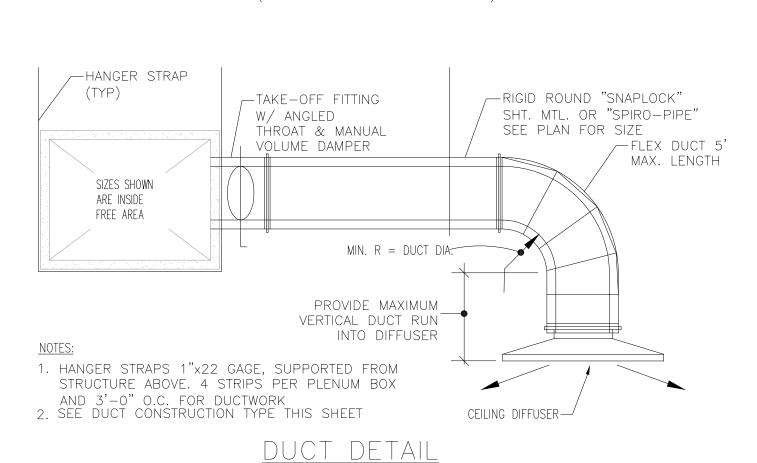


NO SCALE


NOTE: MAXIMUM PERMISSIBLE SAG PER FOOT 1/2" BETWEEN SUPPORTS. FLEXIBLE DUCT HANGER & CONNECTION DETAILS

FLEXIBLE DUCT HANGER DETAILS

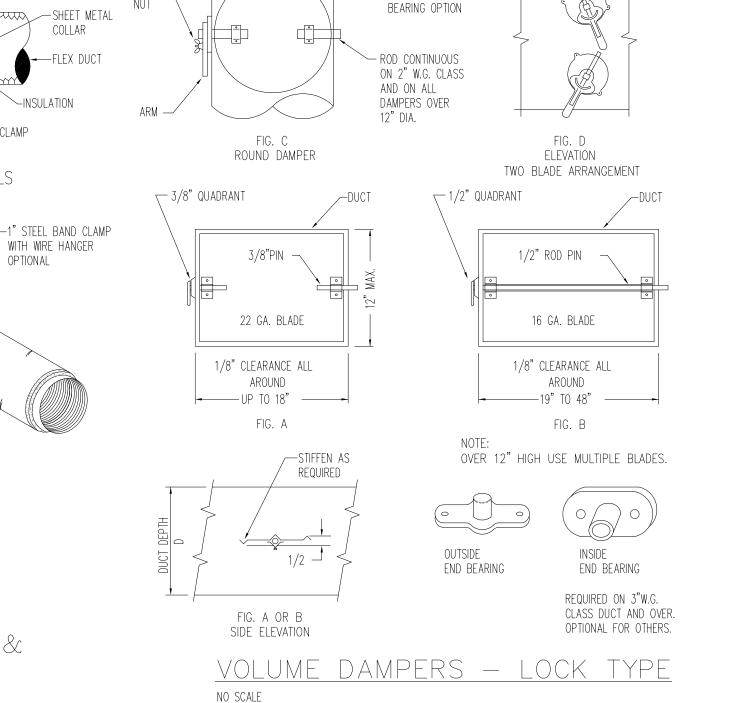

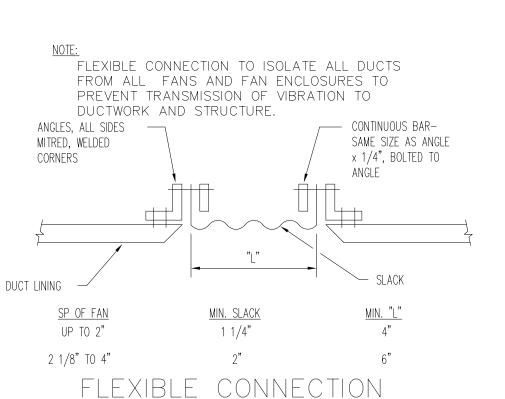

NO SCALE

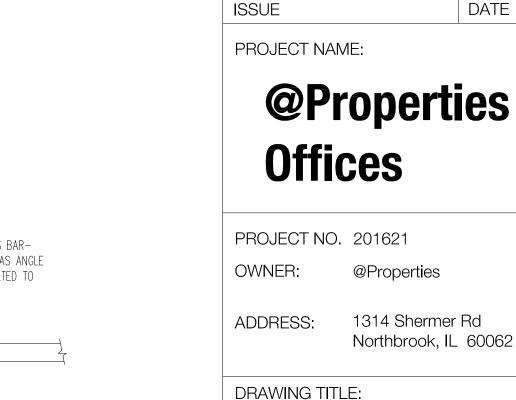

**MECHANICAL** SCHEDULES & **DETAILS** 

REISSUED FOR PERMIT

ISSUED FOR PERMIT

Mechanical, Electrical, Plumbing

Engineering and Consulting

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Oak Brook, IL, 60523

www.trustedengineering.com

I.P.D.F. # 184-005121

EXP. 04/30/2017

I hereby certify that these plans were

prepared by me, or under my direct supervision and control, and to the

JASON L.

DYER 062-059110

DRAWINGS SIGNED 02/16/17

applicable codes.

Jason L. Dyer, P.E.

062059110

Registration Number:

Illinois Professional Engineer

License Expires: 11/30/2017

best of my knowledge, comply with all


DRAWING NO:

M.200

2017-02-16

2016-12-23

DATE

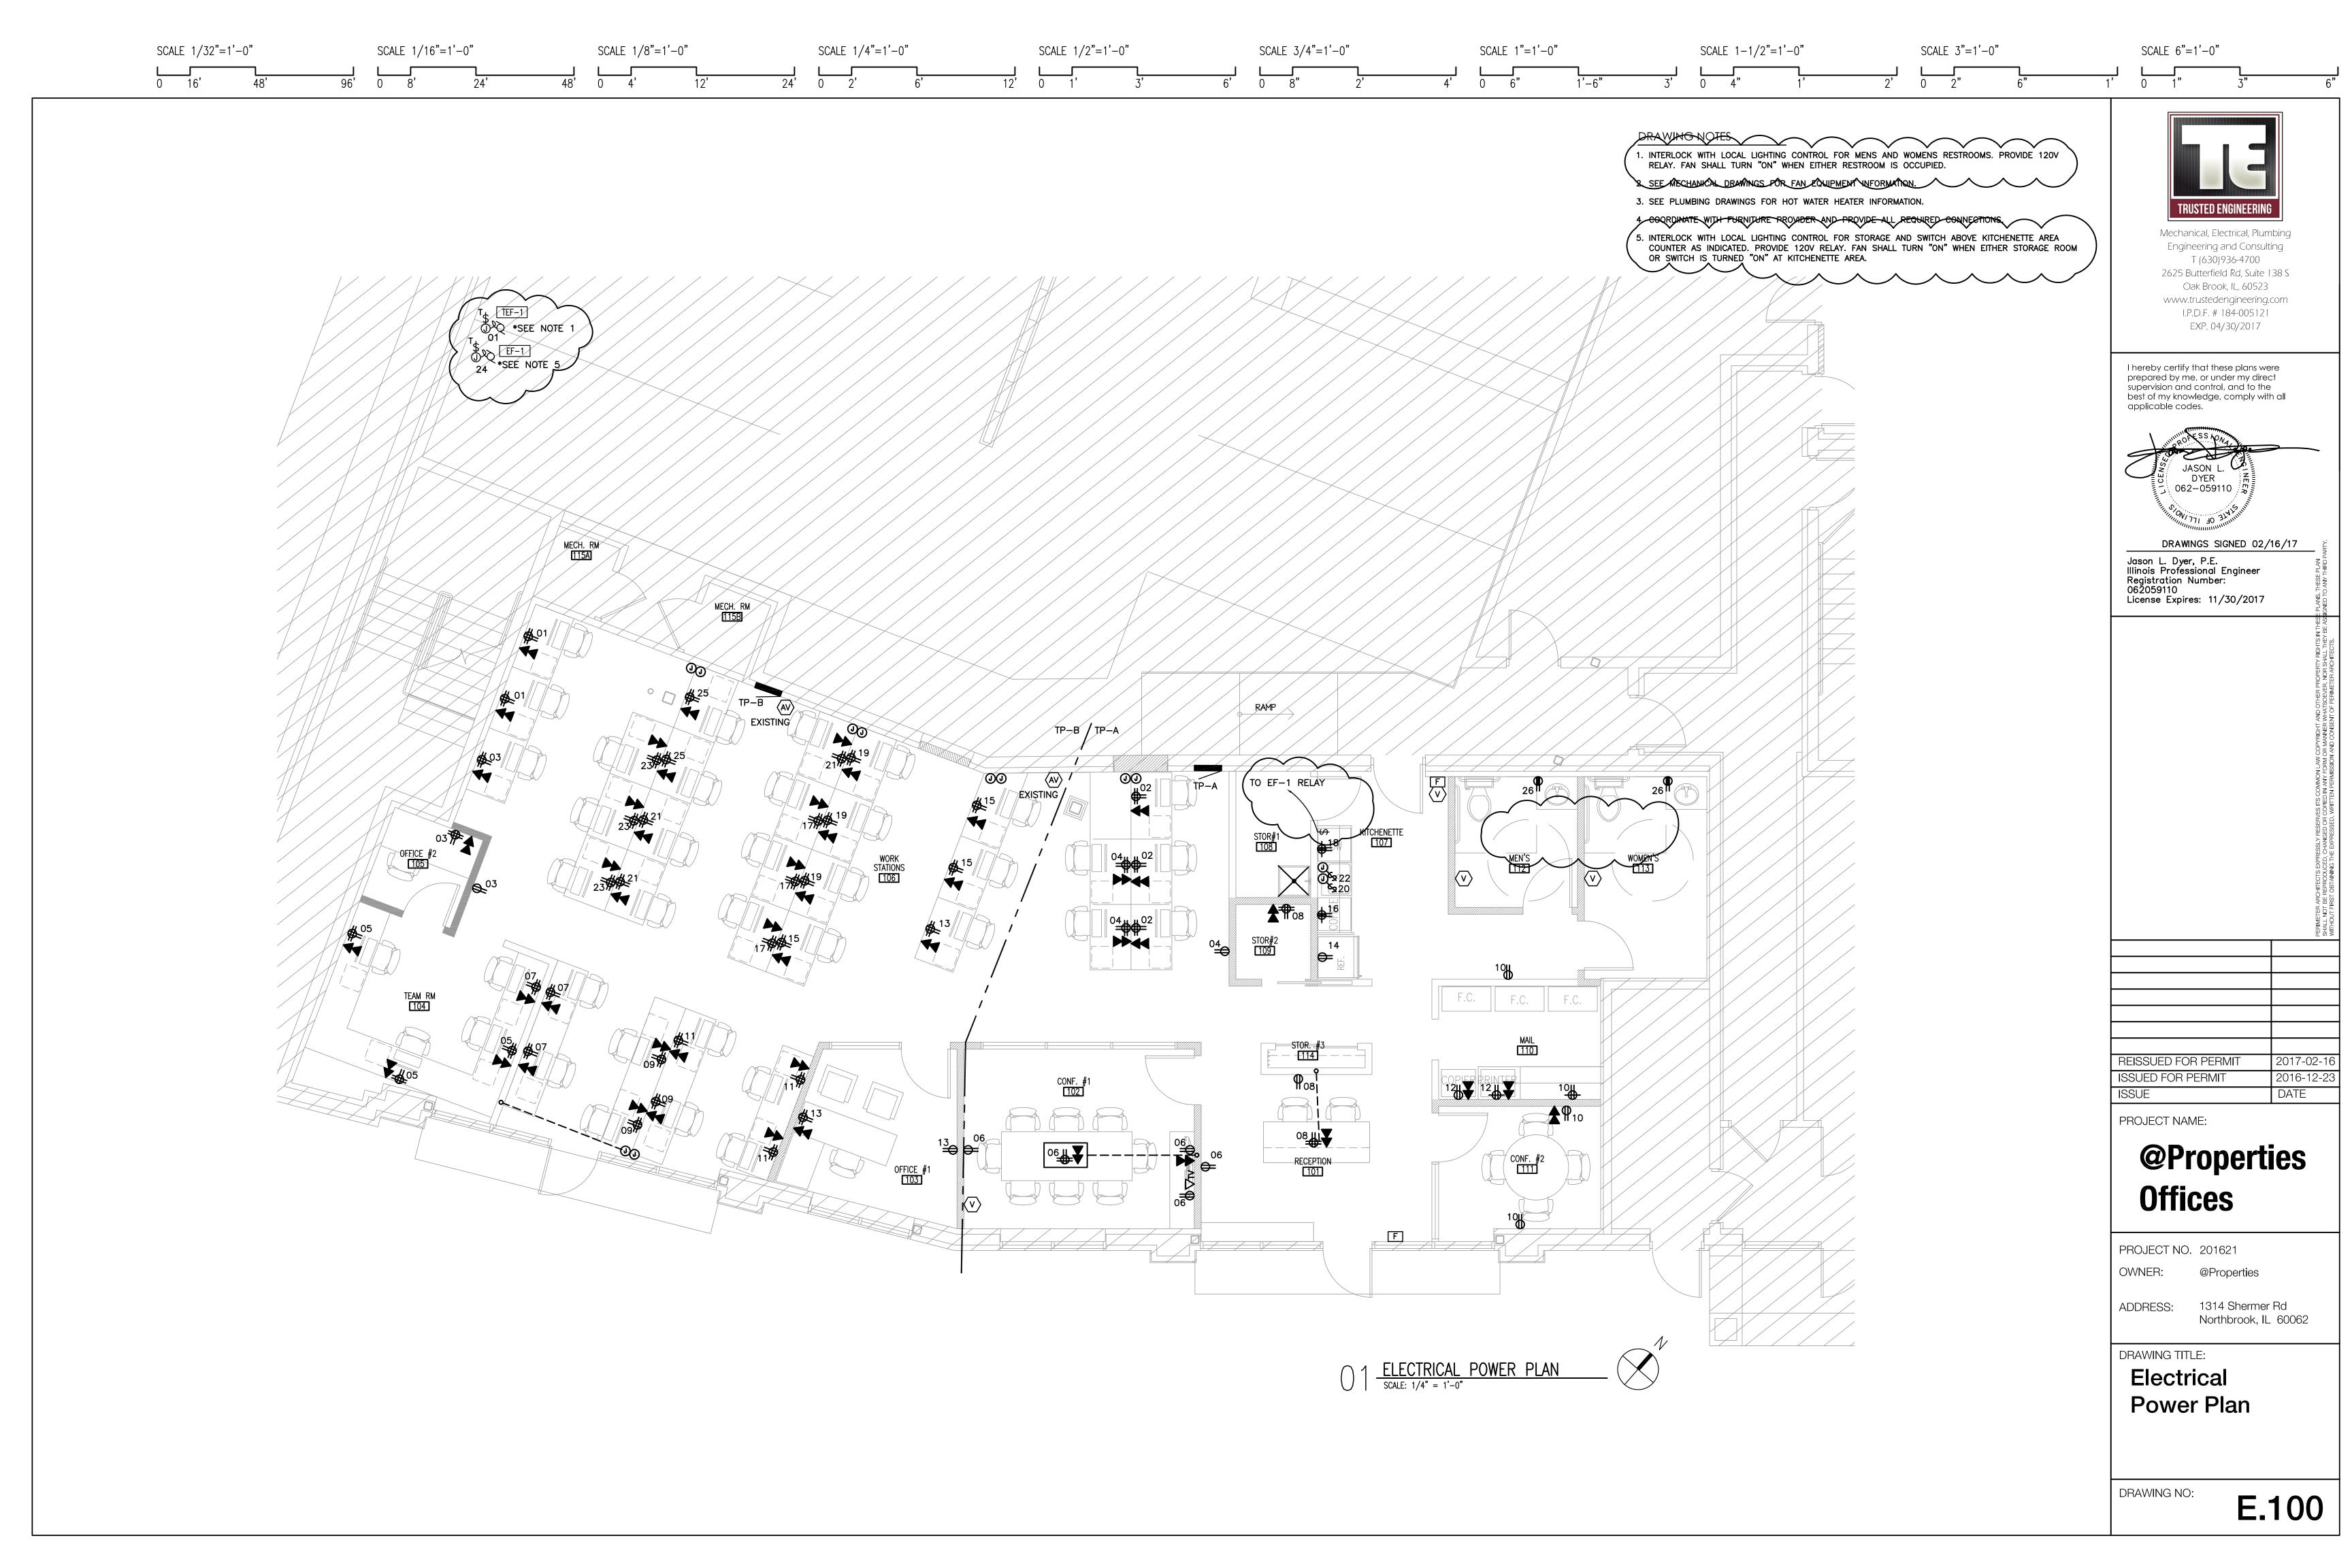

SCALE 1/32"=1'-0" SCALE 1"=1'-0" SCALE 1/16"=1'-0"SCALE 1/8"=1'-0"SCALE 1/4"=1'-0" SCALE 1/2"=1'-0" SCALE 3/4"=1'-0"SCALE 1-1/2"=1'-0" SCALE 3"=1'-0" SCALE 6"=1'-0"

#### DRAWING NOTES

- 1. ALL EMERGENCY BATTERY LIGHTING AND EXIT SIGNS SHALL BE CONNECTED TO LOCAL LIGHTING CIRCUIT, AHEAD OF ANY SWITCHING. (TYPICAL)
- 2. ALL LIGHTING CIRCUITRY SHALL EMANATE FROM EXISTING PANEL TP-A.



Mechanical, Electrical, Plumbing Engineering and Consulting T (630)936-4700 2625 Butterfield Rd, Suite 138 S Oak Brook, IL, 60523 www.trustedengineering.com I.P.D.F. # 184-005121 EXP. 04/30/2017

I hereby certify that these plans were prepared by me, or under my direct supervision and control, and to the best of my knowledge, comply with all applicable codes.



DRAWINGS SIGNED 02/16/17

Jason L. Dyer, P.E.
Illinois Professional Engineer
Registration Number:
062059110 License Expires: 11/30/2017

REISSUED FOR PERMIT 2017-02-16 2016-12-23 DATE ISSUED FOR PERMIT

PROJECT NAME:

# @Properties **Offices**

PROJECT NO. 201621

@Properties OWNER:

ADDRESS:


1314 Shermer Rd Northbrook, IL 60062

DRAWING TITLE:

Electrical **Lighting Plan** 

DRAWING NO:

E.200

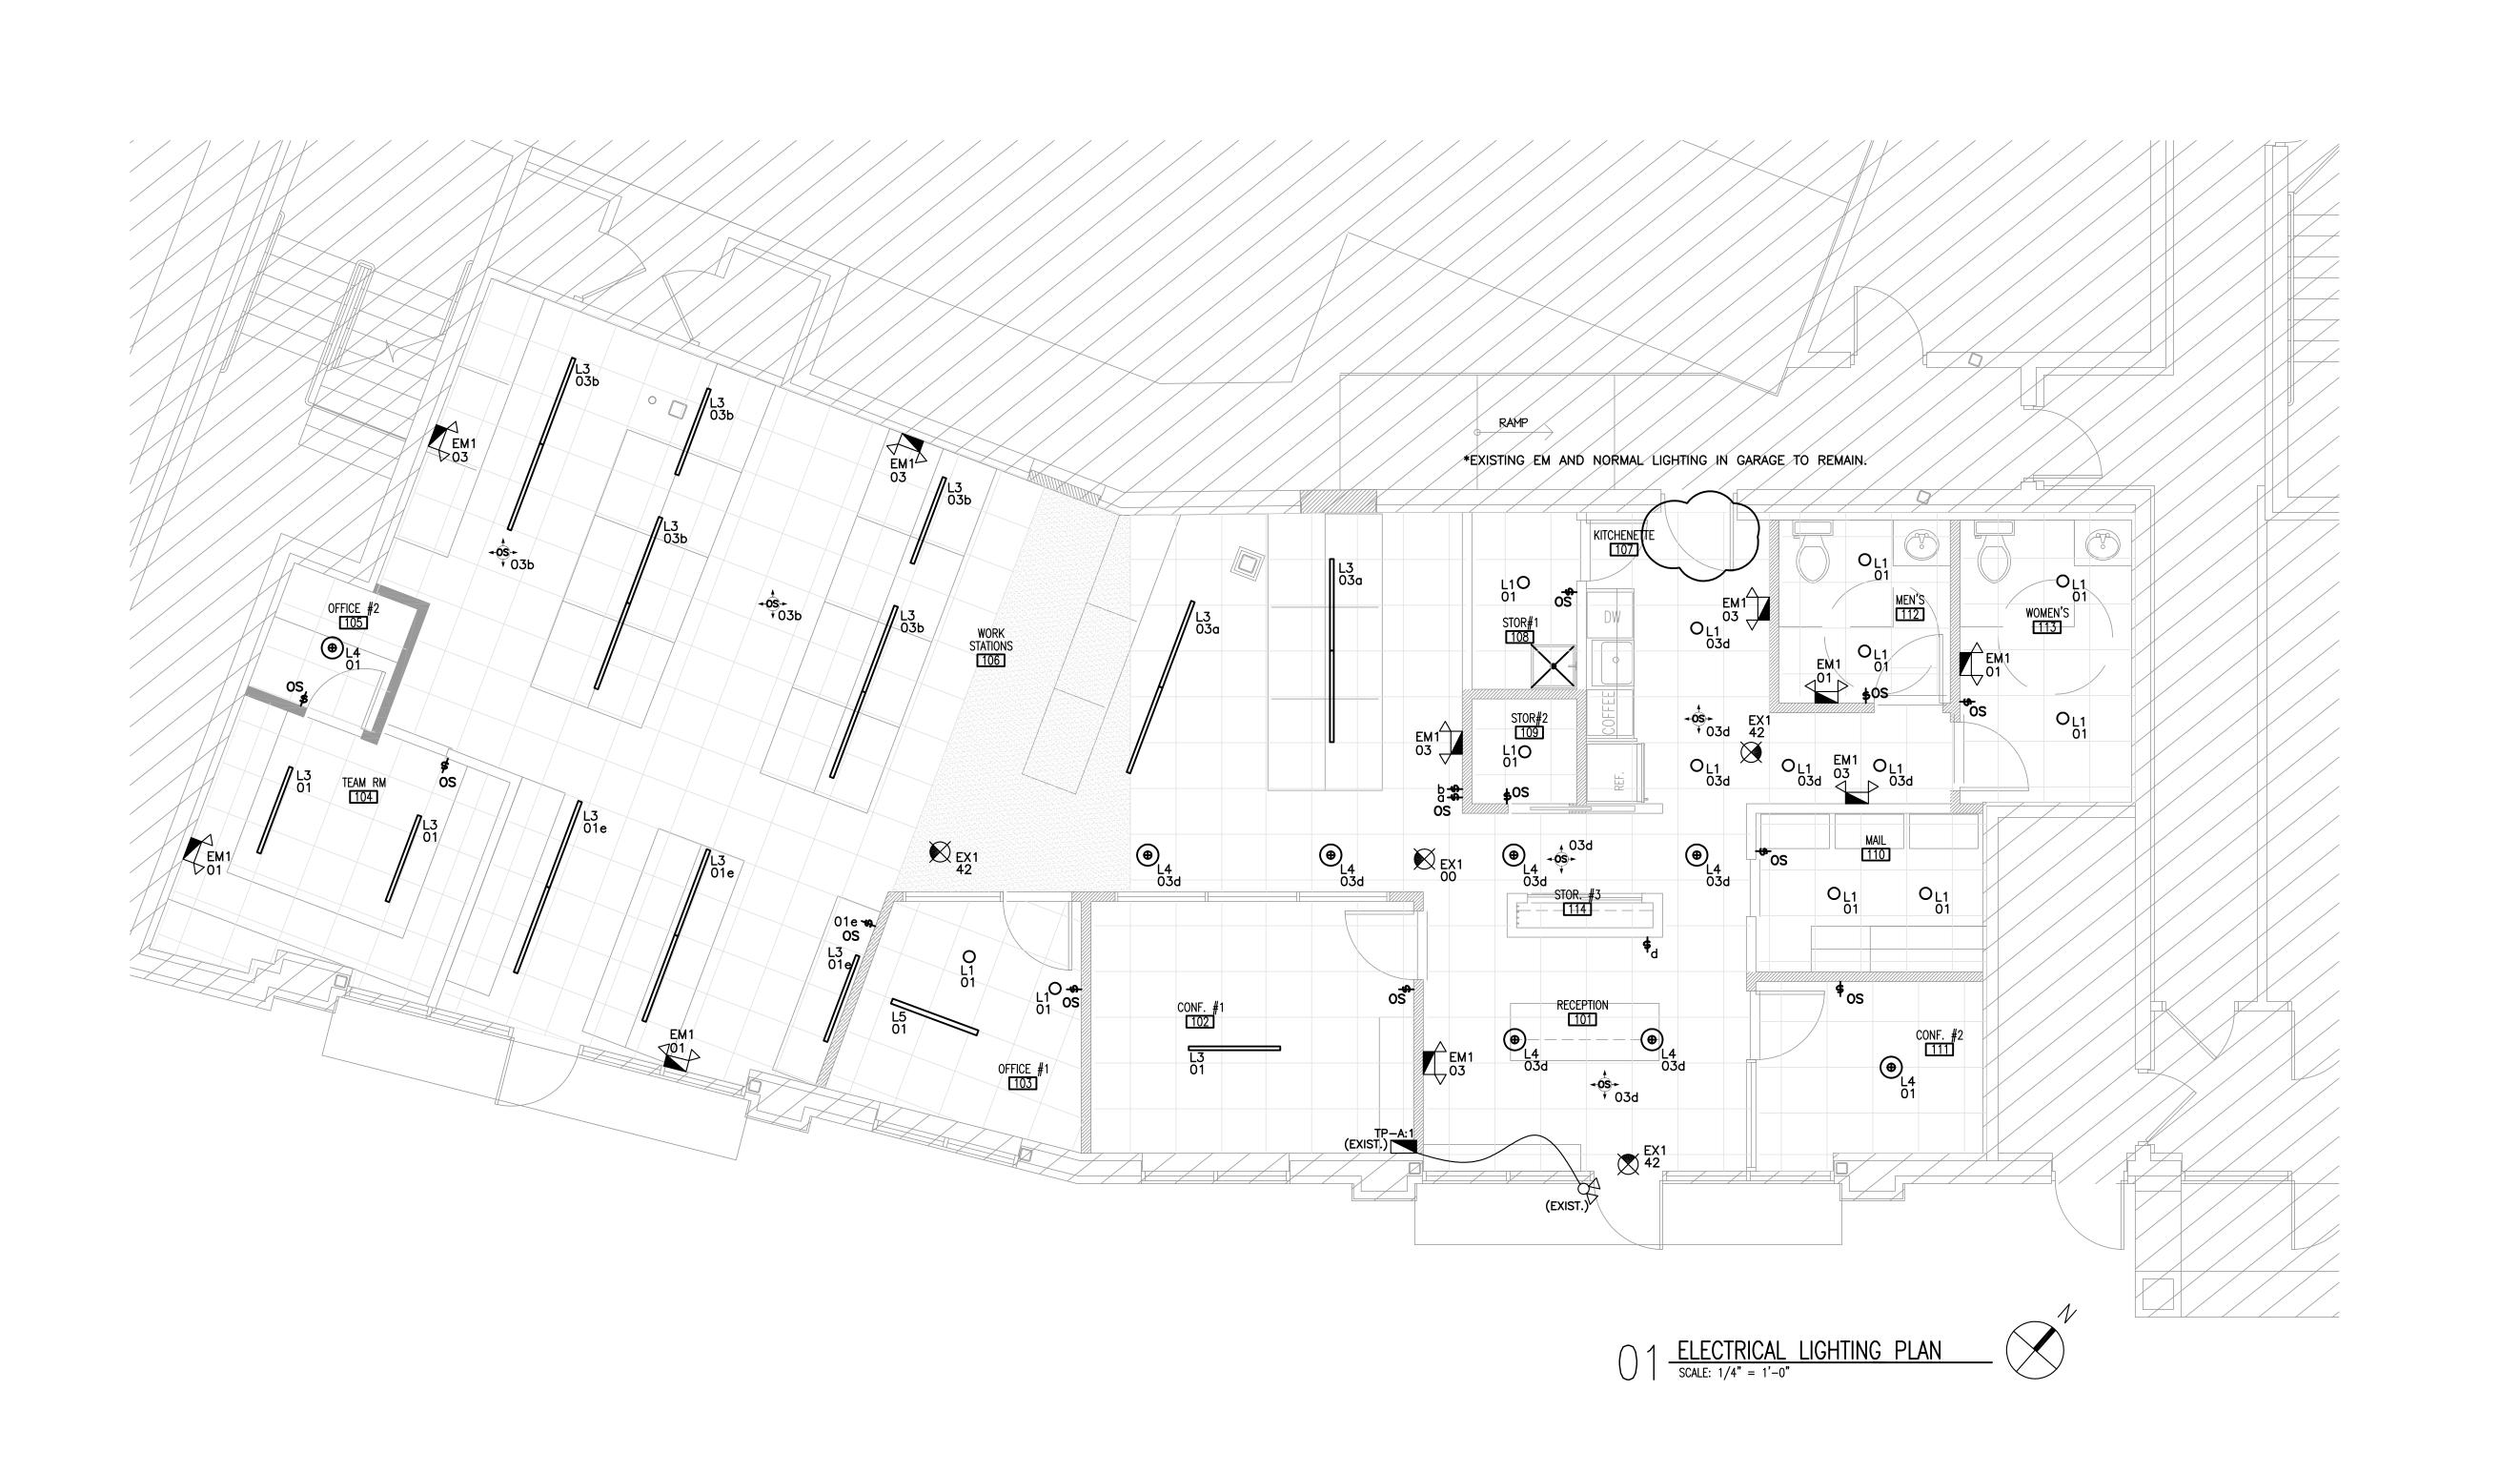

SCALE 1/16"=1'-0"

PAC	ES MOUNTING LOCATION MAIN 42 SURFACE BRKR				VOLT		. 3ø, 4W						AIC: 65	,000 V.I.F.	
KT.	DESCRIPTION	A Ø	ADS VA	_	BKR SIZE	POLE	A B C	BKR SIZE	POLE	A	LOAD:		5	DESCRIPTION	CK NO
1	RECEPTACLES	900			20	1									2
3	RECEPTACLES		900		20	1									4
5	RECEPTACLES			1080	20	1									6
7	RECEPTACLES	1080			20	1									8
9	RECEPTACLES		1080		20	1									1(
11	RECEPTACLES			1080	20	1									12
13	RECEPTACLES	900			20	1									1 4
15	RECEPTACLES		1080		20	1	+++								1 (
17	RECEPTACLES			1080	20	1	+ + +								18
19	RECEPTACLES	1080			20	1									20
21	RECEPTACLES		1080		20	1	+++								22
23	RECEPTACLES			1080	20	1									24
25	RECEPTACLES	1080			20	1									2
27					20	1	+++								2
29					20	1									30
31							+								32
33															34
35	F-4 FURNACE			1752	20	1	+   •								36
37	ROOFTOP CU-4 CONDENSING UNIT	1944													38
39			1944		25	3	+++								40
41				1944			+ + +	20	1			0	SPARE		42
	TOTAL	6984	6084	8016					TOTAL	0	0	0			

#### NOTES:

- 1. CIRCUIT BREAKERS SERVING EXIT SIGNS AND EM. (24-HR) LIGHTING SHALL BE KEY OPERATED TYPE.
- 2. CIRCUIT BREAKERS SERVING HVAC EQUIPMENT AND WH-1 SHALL BE HACR RATED.
- VERIFY EXISTING FAULT CURRENT AND PROVIDE SERIES RATED CIRCUIT BREAKERS.

SCALE 1/32"=1'-0"

		T		(TURE SC	1			
SYM.	M. TAG ITEM		MANUFACTURER	MODEL#	TRIM/HOUSING	LAMP TYPE	WATTAGE	COMMENTS
0	L1	6" CAN	JUNO	24W-WH	WHITE	LED 120V		
0	L2	UTILITY	BEGA	5123P	WHITE			MAGNETIC ACTUATOR
_	L3	4' DIRECT/INDIRECT LED	PEERLESS	RD4M4	WHITE			W20/40
•	L4	DECORATIVE PENDANT	SOPRANA	7155710	GREY	120V		
_	L5	DECORATIVE PENDANT	ARTEMIDE	TALO 150 SUSPENSION	SILVER/ GREY	54W		
	L6	4' INDUSTRIAL STRIP			WHITE REFLECTOR	(4) 32W T8		SUSPENDED FROM STRUCTURE
	EM1	EMERGENCY LIGHT						90 MINUTE BATTERY
Ø	EX1	EXIT SIGN						90 MINUTE BATTERY
NOTES:		TING IN ROOM BOTH DIREC	ΠΟΝ. U.N.O.					

#### GENERAL NOTES

SCALE 3/4"=1'-0"

SCALE 1/2"=1'-0"

SCALE 1/4"=1'-0"

SCALE 1/8"=1'-0"

- 1. PAY FOR & OBTAIN ALL REQUIRED LICENSES, INSURANCES, PERMITS & SATISFY NECESSARY ORDINANCES TO UNDERTAKE & EXECUTE THE WORK UNDER THIS CONTRACT.
- 2. THOROUGHLY FAMILIARIZE YOURSELF WITH THE EXISTING SITE CONDITIONS & THE SCOPE OF WORK BEFORE SUBMITTING YOUR BID. REQUESTS FOR EXTRA PAYMENTS WILL NOT BE APPROVED AFTER
- 3. ALL WORK SHALL BE PERFORMED IN COMPLIANCE WITH REQUIREMENTS OF THE NATIONAL ELECTRIC CODE & OTHER CODES, STANDARDS & REGULATIONS REFERENCED BY THE CITY OF NORTHBROOK, IL

IN CASE OF CONFLICT BETWEEN TWO CODES, THE REQUIREMENT OF THE LOCAL AUTHORITY SHALL BE

SCALE 1"=1'-0"

- 4. COORDINATE ELECTRICAL INSTALLATION WITH WORK BY OTHER TRADES BEFORE STARTING WORK. PERFORM ALL WORK IN COOPERATION WITH LANDLORD, G.C. & OTHER TRADES.
- 5. ALL MATERIAL/ EQUIPMENT SHALL BE NEW, U.L. LISTED, WITHOUT DEFECT & DAMAGE AND SHALL BE A STANDARD PRODUCT OF A MANUFACTURER WITH A WELL KNOWN BRAND NAME, U.N.O. WIRING DEVICES SHALL BE SPECIFICATION GRADE. FINISH OF ALL ITEMS INSTALLED IN FINISHED AREAS SHALL BE PER ARCHITECT.
- 6. DRAWINGS ARE SCHEMATIC IN NATURE. THEY DO NOT INTEND TO SHOW EVERY DETAIL, LOCATION, SIZE, ROUTE ETC. FURNISH ALL MATERIAL, EQUIPMENT, INCIDENTALS & SERVICES TO PROVIDE A SATISFACTORY, COMPLETE & OPERATIONAL INSTALLATION. REFER TO ARCHITECTURAL DWGS FOR DIMENSIONAL ACCURACY.
- 7. PROVIDE TEMPORARY ELECTRICAL SERVICE AND PROVIDE TEMPORARY LIGHTING & POWER FOR USE BY ALL TRADES DURING CONSTRUCTION, AS NECESSARY.
- 8. ARCHITECT MAY REVIEW SUBMITTAL OF AN ALTERNATE PRODUCT PROVIDED IT HIGHLIGHTS ALL THE FEATURES & DATA TO CLEARLY ILLUSTRATE THAT IT IS A BONAFIDE EQUIVALENT PRODUCT IN MAKE & PERFORMANCE. ARCHITECT SHALL NOT REVIEW A SUBMITTAL NOT DEEMED RESPONSIVE IN THIS REGARD.
- 9. ALL ENCLOSURES SHALL BE NEMA-1, IN GENERAL. GFI RECEPTACLES SHALL BE USED IF SPECIFIED OR CODE REQUIRED. WIRING DEVICES SHALL BE SPECIFICATION GRADE. ALL INSTALLATION IN CEILING SHALL BE ACCEPTABLE FOR PLENUM SPACE, AS APPLICABLE. NAME PLATES SHALL BE PHENOLIC, WHITE LETTERS ON BLACK BACKGROUND, SECURED WITH SCREWS ON THE ENCLOSURES.
- 10. USE MINIMUM 3/4" EMT. USE COMPRESSION FITTINGS OR SET SCREW PLUS GROUND. USE TYPE THWN. COPPER WIRE IN MINIMUM #12 AWG FOR BRANCH CCTS & #14 FOR CONTROLS WITH MINIMUM 1/2" EMT, U.N.O. USE LIQUID-TIGHT FLEX CONDUIT IN AREAS EXPOSED TO MOISTURE.
- 11. USE MIN. SIZE '0' STARTERS. FUSES SHALL BE TIME DELAY, DUAL ELEMENT REJECTION TYPE, U.N.O.
- 12. SEAL PENETRATIONS CAUSED BY THE ELECTRICAL WORK THROUGH VAPOR, FIRE & PLENUM BARRIERS TO RETAIN THE INTEGRITY OF THE RESPECTIVE BARRIERS.
- 13. INSTALLATION IN CEILING SPACE SHALL BE SUPPORTED FROM THE STRUCTURAL STEEL & NOT BY THE DROPPED CEILING MEMBERS. CONDUITS SHALL RUN SNUG UNDER STRUCTURAL CEILING EITHER PARALLEL OR PERPENDICULAR TO THE CEILING, COLUMNS & STRAIGHT WALLS. INSTALL PULL BOXES PER CODE. INSTALL PULL-LINES IN EMPTY RACEWAYS & CAP THEM.
- 14. INSTALLATION SHALL BE PERFORMED IN A MANNER CONSISTANT WITH INDUSTRY STANDARD FOR GOOD WORKMANSHIP. PROVIDE NECESSARY CUTTING, PATCHING, & CLEANING FOR MECHANICAL AND ELECTRICAL WORK TO LEAVE THE AREA READY FOR FINAL FINISH BY OTHERS.
- 15. PROGRESS YOUR WORK IN TIMELY MANNER TO ENABLE THE OWNER TO FINISH THE WORK PER SCHEDULE. SAFEGUARD YOUR WORK & SUPPLIES. MAINTAIN ORDERLY & NEAT OPERATION. REMOVE DEBRIS GENERATED FROM YOUR WORK PER G.C. & LANDLORD. LEAVE THE SITE IN CLEAN, MOVE-IN
- 16. ORGANIZE ALL WARRANTEES, GUARANTEES & PRODUCT LITERATURE IN A FILE AND HAND OVER THESE TO THE OWNER AT THE TIME OF ACCEPTANCE. PROVIDE FULL & UNCONDITIONAL GUARANTEE OF YOUR WORK (MATERIAL PLUS LABOR) FOR A PERIOD OF 12 MONTHS FROM ACCEPTANCE.
- 17. FLEXIBLE METALLIC CONDUIT IS NOT PERMITTED IN EXPOSED LOCATIONS, IN LENGTHS OVER 3 FEET, OR IN LOCATIONS PROHIBITED BY NATIONAL ELECTRICAL CODE.
- 18. NON-METALLIC CONDUIT IS PERMITTED ONLY IN THE FOLLOWING LOCATIONS:

   IN LOCATIONS SUBJECT TO SEVERE CORROSIVE INFLUENCES
- IN WET LOCATIONS WHERE WALLS ARE WASHED FREQUENTLY.
- UNDERGROUND INSTALLATIONS
- ALL OTHER WIRING MUST BE INSTALLED IN RIGID METALLIC CONDUIT, INTERMEDIATE METALLIC CONDUIT, ELECTRICAL METALLIC CONDUIT, OR FLEXIBLE METALLIC CONDUIT.
- 19. ALUMINUM BUSSING MAY BE UTILIZED IN THE SWITCHBOARD AND PANELBOARDS IF ALLOWED PER CODE. ALUMINUM CABLE MAY BE UTILIZED FOR ALL FEEDERS TO PANELBOARDS IF ALLOWED PER CODE. ALL BRANCH CIRCUITRY SHALL BE COPPER WIRE ONLY.
- 20. TYPE MC CABLE MAY BE USED IN LIEU OF EMT IN CONCEALED SPACES AS ALLOWED PER CODE.
- 21. ALL LOW VOLTAGE CABLING SHALL BE BUNDLED TOGETHER WITH TIE WRAPS AND RUN PARALLEL TO BUILDING LINES. THE BUNDLES SHALL BE SUPPORTED BY "J" HOOKS OR SIMILAR DEVICES SECURED TO STRUCTURE. THERE SHALL BE NO TENSION ON THE LOW VOLTAGE CABLING.
- 22. VERIFY ALL DEVICE MOUNTING HEIGHTS WITH ARCHITECTURAL DRAWINGS PRIOR TO INSTALLATION.
- 23. PROVIDE PROPER CODE REQUIRED FIRE STOPPING METHODS WHERE CABLES OR CONDUITS ARE REQUIRED TO PASS THROUGH A FIRE RATED WALL, FLOOR OR CEILING. PROVIDE MINIMUM 1" EMT THROUGH THESE PENETRATIONS.
- 24. COORDINATE CONDUIT PENETRATIONS THRU ROOF WITH MECHANICAL CONTRACTOR. PORTALS EQUAL TO PATE MODEL PCC-1 WITH PVC BOOT SHALL BE UTILIZED.
- 25. A PERMANENTLY AFFIXED LABEL SHALL BE APPLIED WITH THE AVAILABLE FAULT CURRENT AT THE TIME OF INSTALLATION AND CALCULATION. THE LABEL SHALL BE  $2" \times 3"$  In size and shall be blue lettering on a contrasting background. This label shall also include the date of the

#### SYMBOL LIST

SCALE 1-1/2"=1'-0"

- ⇒ DUPLEX RECEPTACLE 120V, NEMA 5-20R AT 15" AFF, U.N.O.
- **⊕** DUPLEX RECEPTACLE 120V, NEMA 5-20R AT 6" ABOVE COUNTER, U.N.O.
- DUPLEX RECEPTACLE 120V, NEMA 5-20R,
- GROUND FAULT INTERRUPTER TYPE (GFI) DUPLEX RECEPTACLE 120V, NEMA 5-20R,

GFI, 6" ABOVE COUNTER, U.N.O.

- ₩ QUAD TYPE RECEPTACLE 120V, NEMA 5-20R AT 15" AFF, U.N.O.
- TOGGLE SWITCH, 120V, 20A, 1P @ 48" AFF, U.N.O. SUFFIX "3w" DENOTES 3 WAY
- ROTARY SWITCH, 120V, 10A, 4 SPEED @ 48" AFF, U.N.O. FAN KICHLER 370040, 800W

SCALE 3''=1'-0''

- MANUAL STARTER SWITCH WITH THERMAL O/L ELEMENT
- DATA OUTLET. STUB 1"C TO ABOVE CEILING
- ⟨TV CABLE TV OUTLET. STUB 1"C TO ABOVE CEILING

MOTORIZED EQUIPMENT

VERIFY EXACT LOCATION IN FIELD NON-FUSED DISCONNECT SWITCH

JUNCTION BOX

ELECTRICAL PANEL

FLEXIBLE CONDUIT

NIGHT LIGHT

WEATHER PROOF

OCCUPANCY SENSOR - WALL MTD - ULTRA SONIC/ PASSIVE INFRARED - WATTSTOPPER DSW-100-G 800W, 120V, FINISH GREY

TIME CLOCK - 24 HOUR, 7 DAY, SPST ELECTRONIC TIME SWITCH INTERMATIC ET1100 OR EQUIVALENT

TRANSFORMER

BATTERY LIGHT W/90 MINUTE BATTERY BACK-UP

REMOTE BATTERY LIGHT HEADS, WEATHERPROOF

DRAWING LEGEND

**NEW WORK** 

**EXISTING TO REMAIN** 

EXIT SIGN/BATTERY LIGHT COMBO W/90 MINUTE BATTERY BACK-UP


OCCUPANCY SENSOR - CLNG MTD - ULTRA SONIC/ PASSIVE INFRARED - DUAL TECH 1000SQ FT WATTSTOPPER DT-355 800W, 120V, PAINT TO BLACK/REMOVABLE FACE



SCALE 6"=1'-0"

Mechanical, Electrical, Plumbing Engineering and Consulting T (630)936-4700 2625 Butterfield Rd, Suite 138 S Oak Brook, IL, 60523 www.trustedengineering.com I.P.D.F. # 184-005121 EXP. 04/30/2017

I hereby certify that these plans were prepared by me, or under my direct supervision and control, and to the best of my knowledge, comply with all applicable codes.

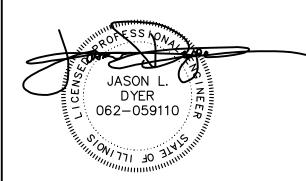

DRAWINGS SIGNED 02/16/17

Jason L. Dyer, P.E.
Illinois Professional Engineer Registration Number: 062059110 License Expires: 11/30/2017

2017-02-16 REISSUED FOR PERMIT 2016-12-23 ISSUED FOR PERMIT

PROJECT NAME:

## @Properties **Offices**

PROJECT NO. 201621

@Properties OWNER:

ADDRESS:


1314 Shermer Rd Northbrook, IL 60062


DRAWING TITLE:

Electrical Symbols & Notes

DRAWING NO:

E.300

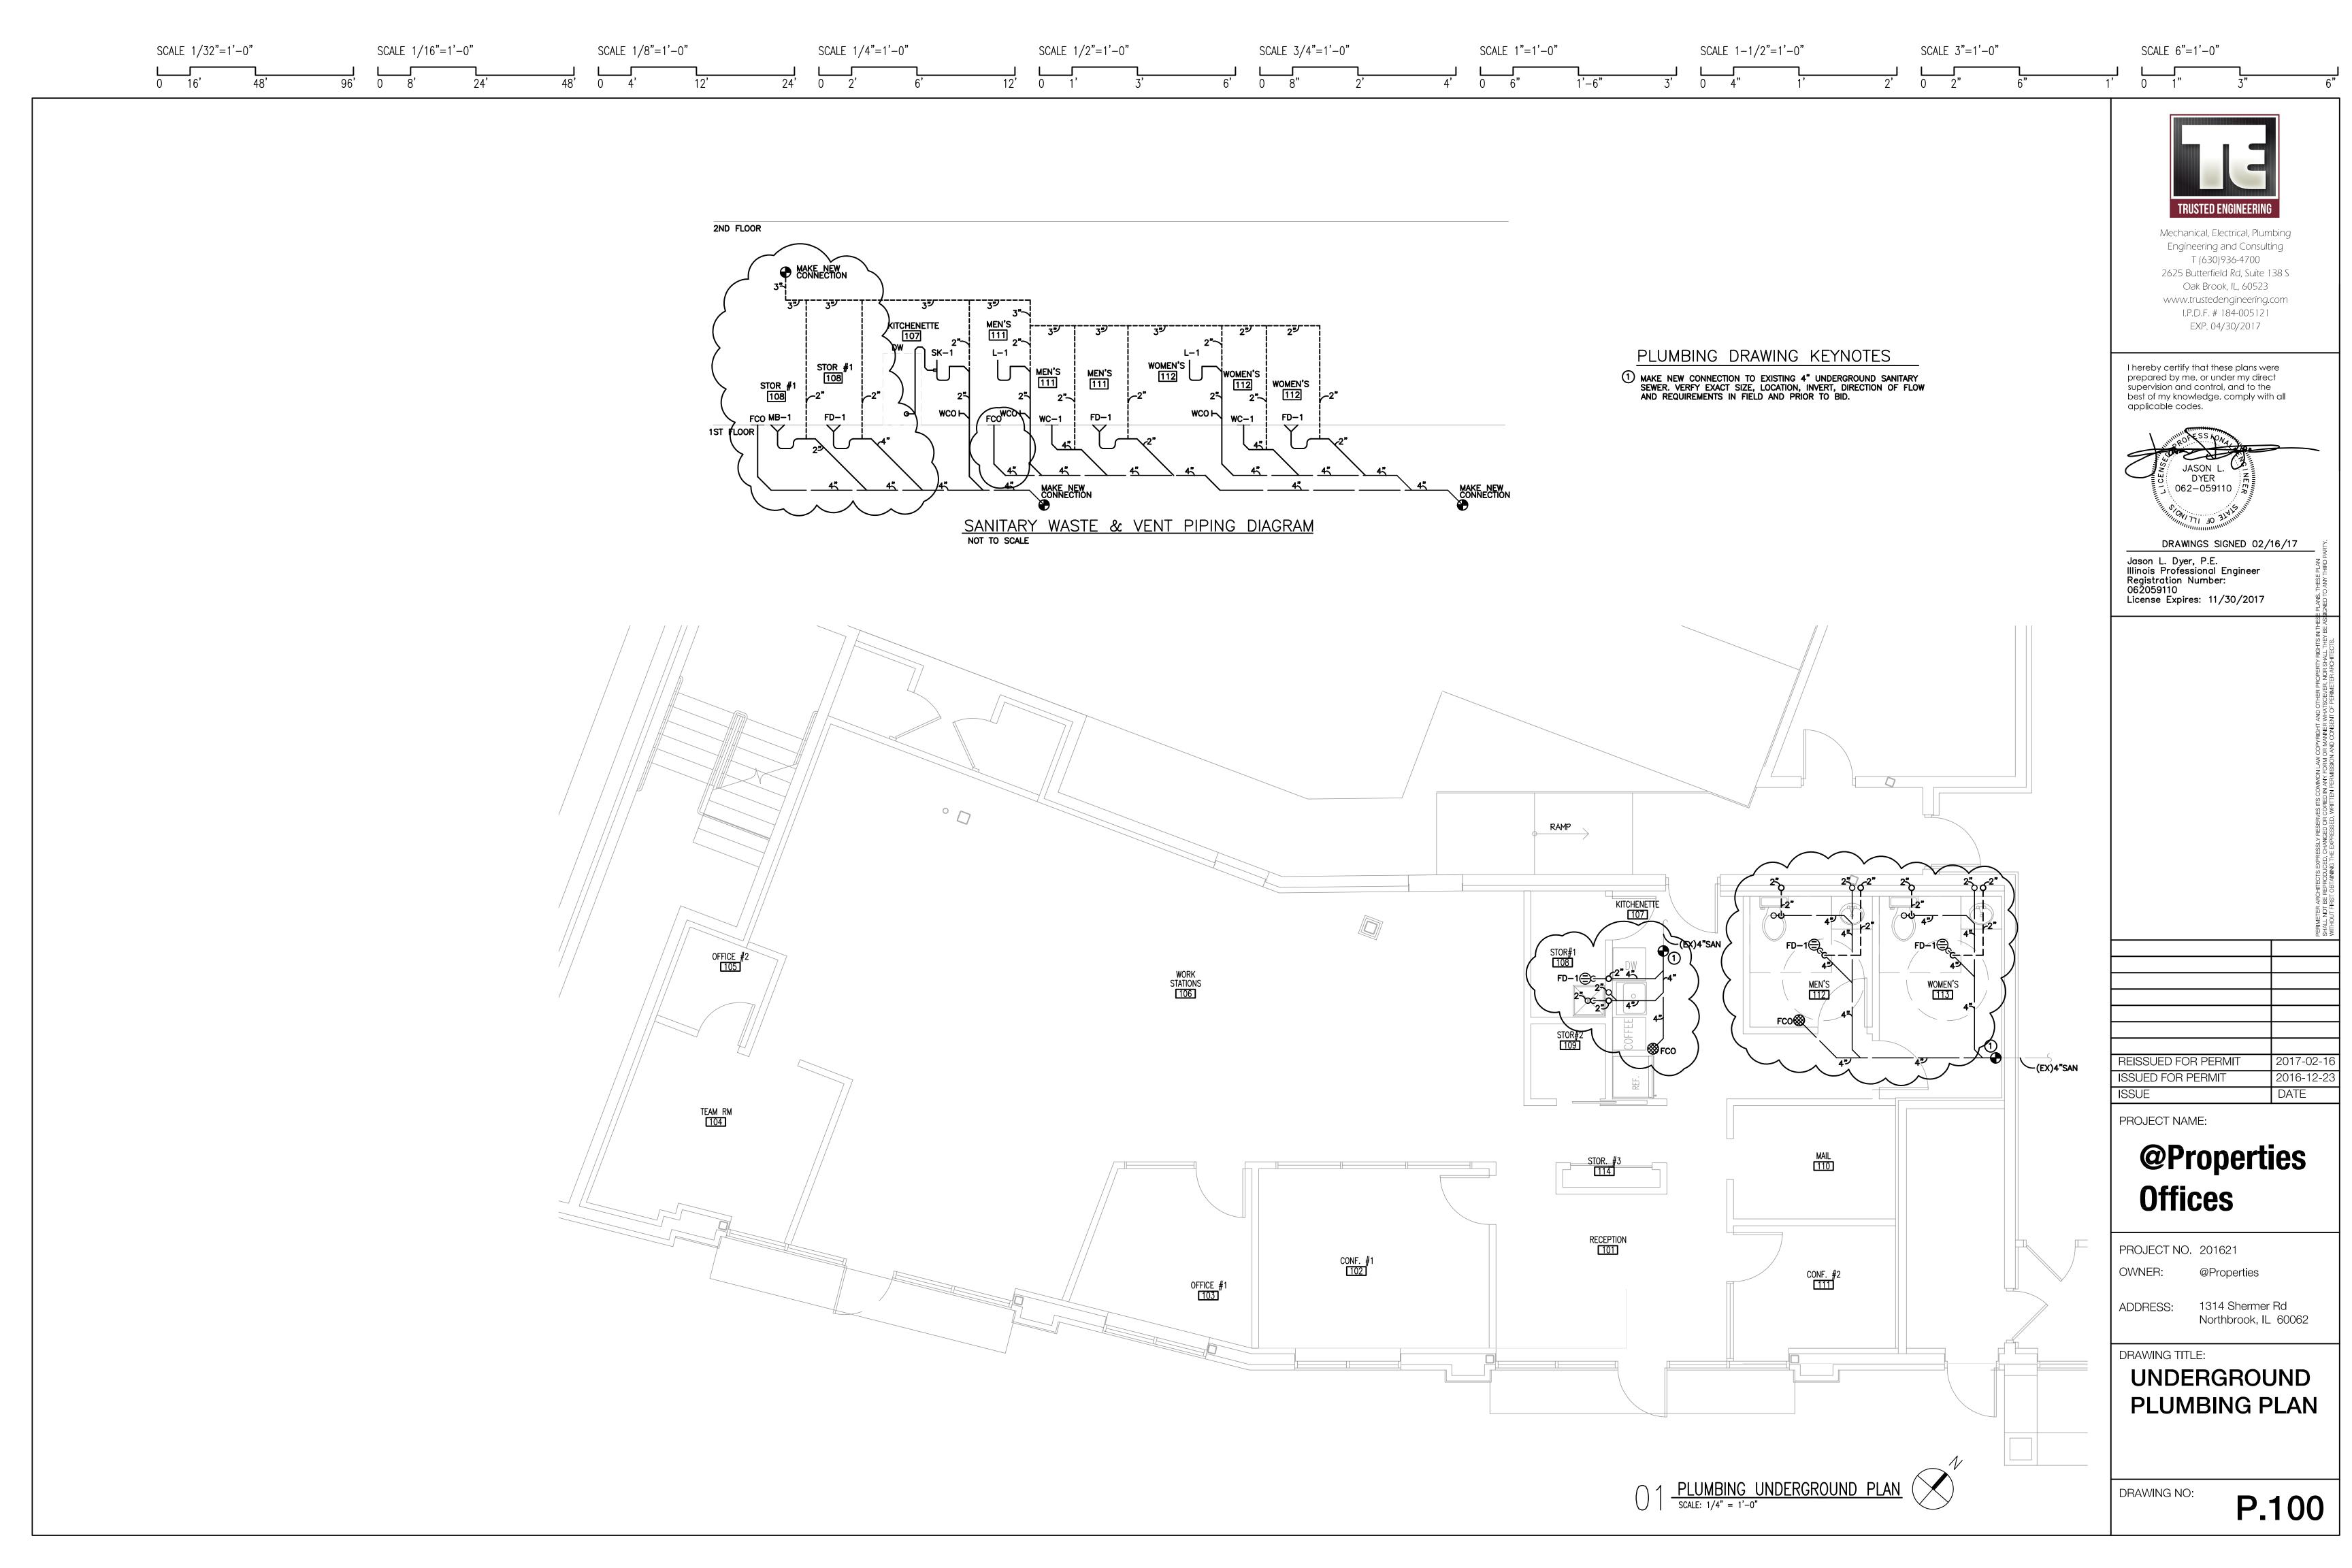

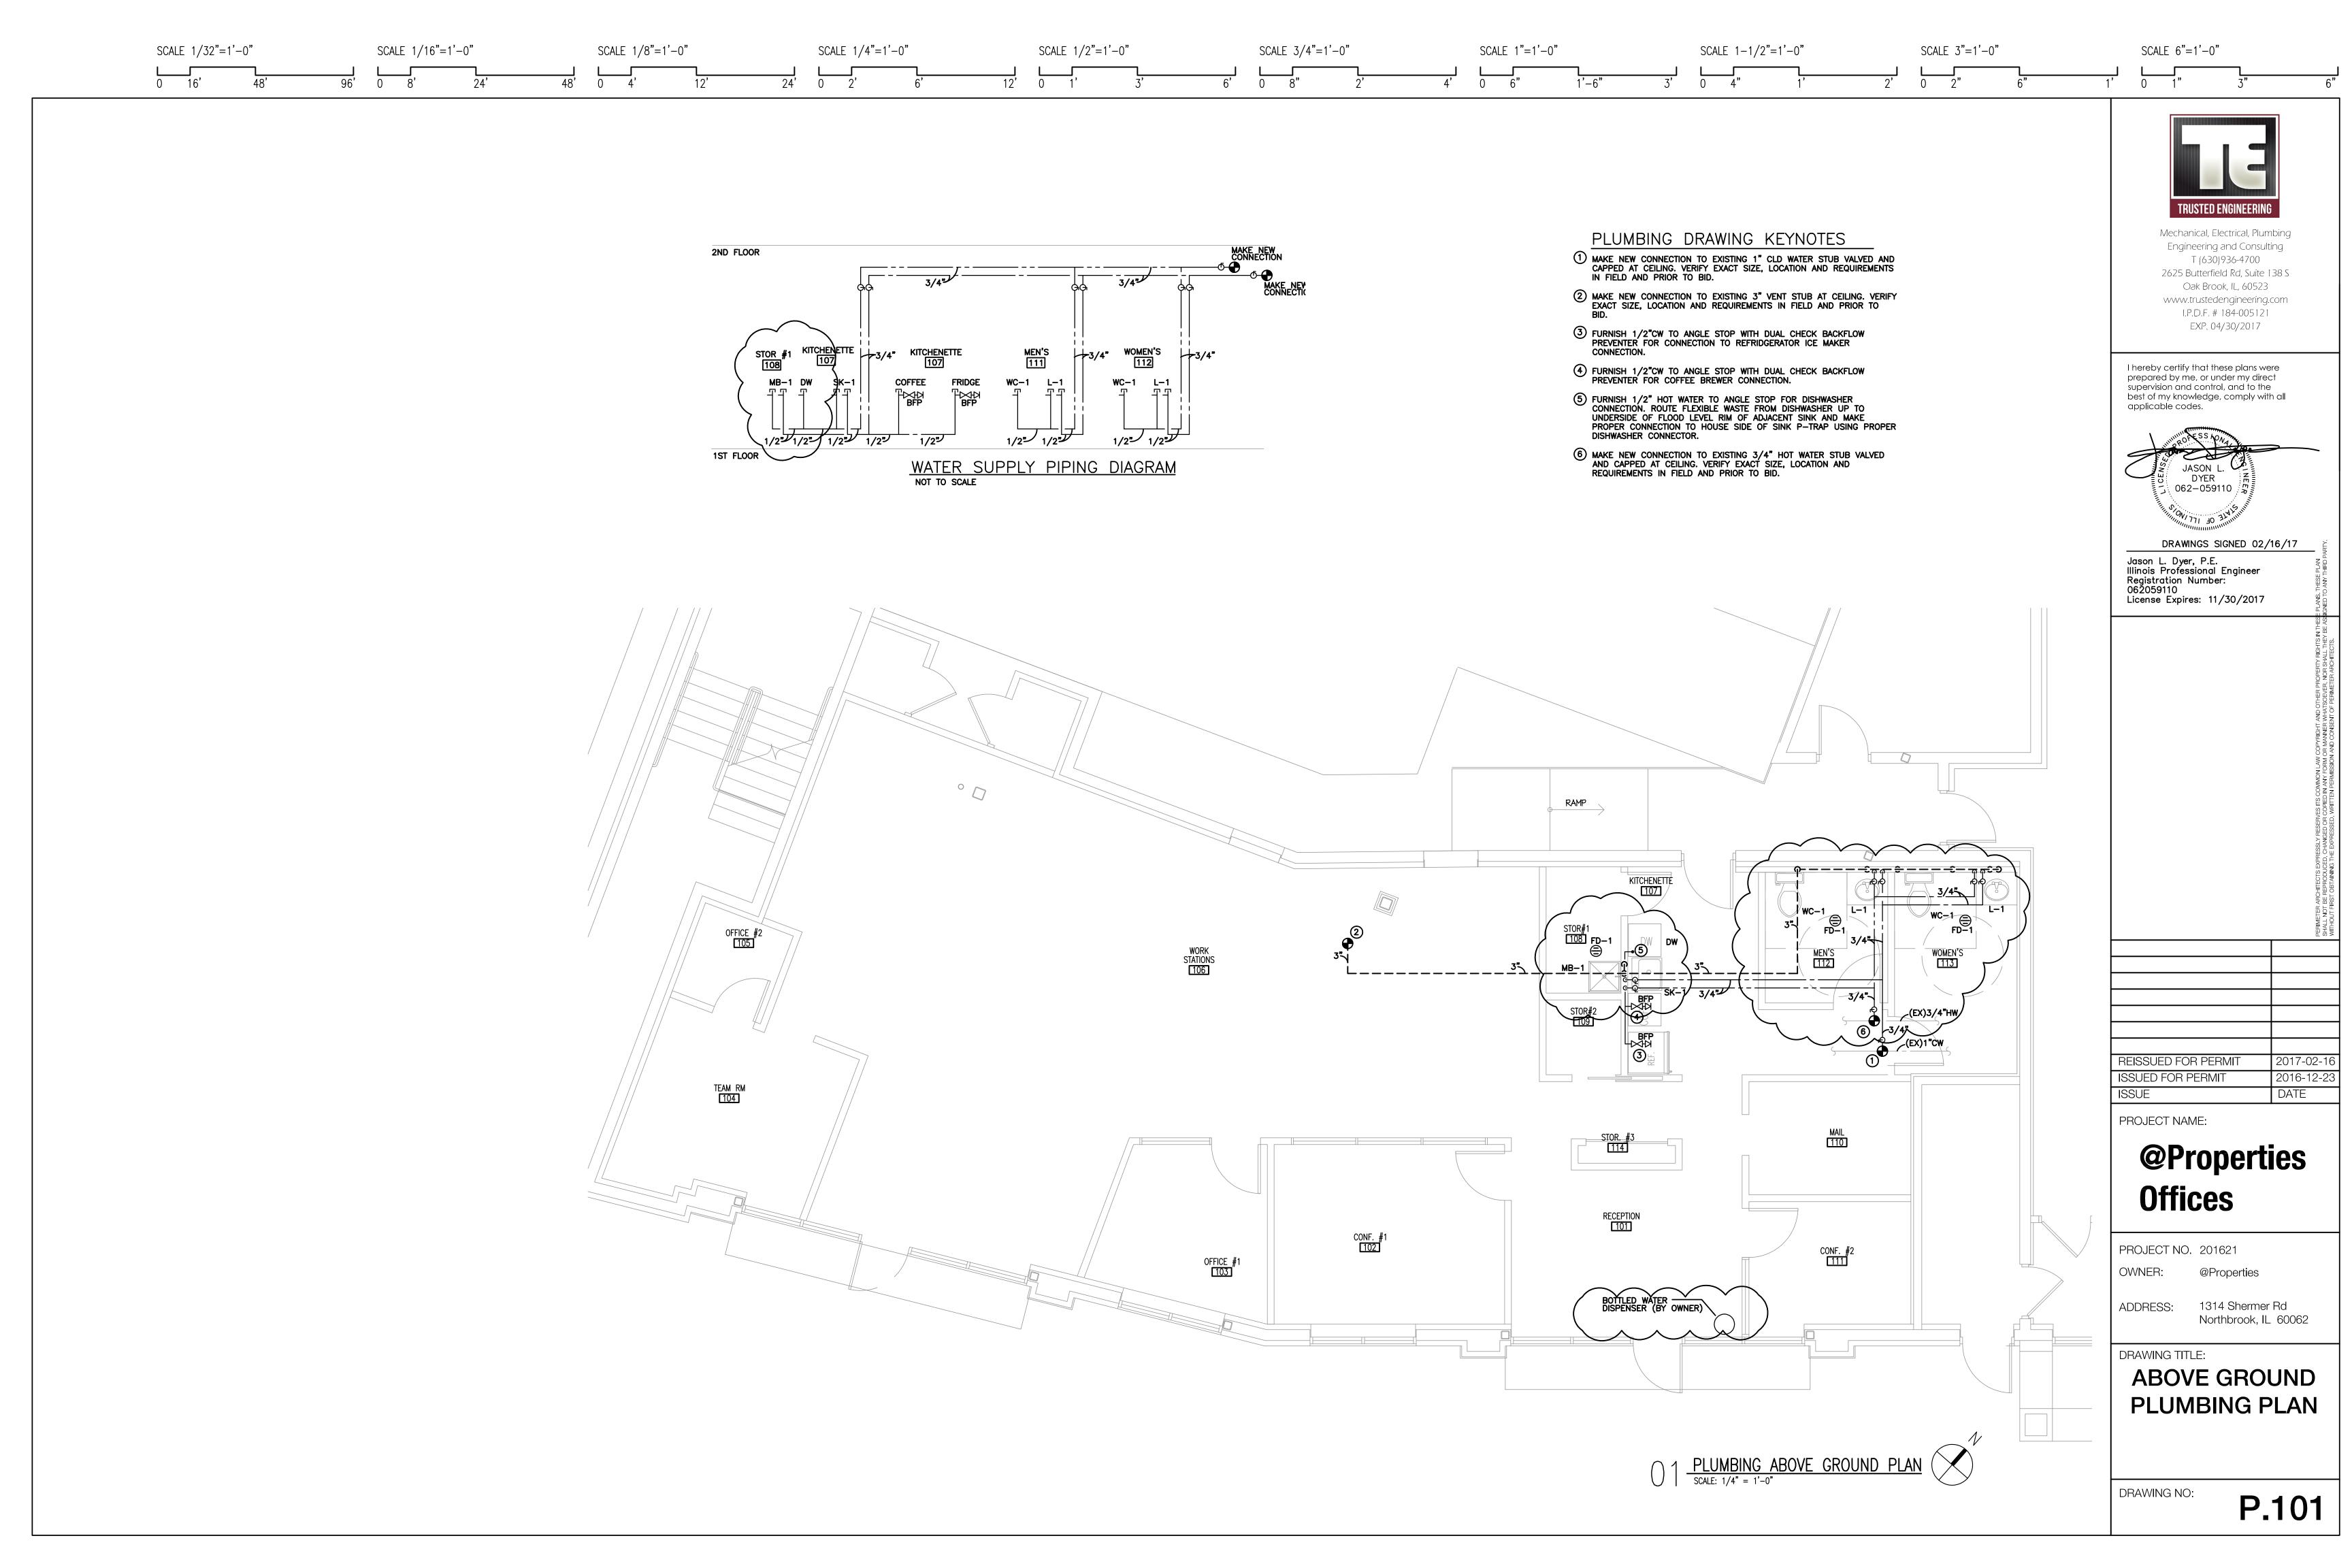

#### PLUMBING FIXTURES & EQUIPMENT SCHEDULE

WC-1 ADA, TWO PIECE, FLOOR MOUNTED, WHITE, VITREOUS CHINA, TANK TYPE WATER CLOSET WITH 16-3/4" HIGH ELONGATED BOWL, 12" ROUGH-IN, CHINA BOLT CAPS, 1.6 GPF, 3" FLUSH VALVE AND 2-1/8" TRAPWAY; MANSFIELD "SUMMIT" 384-386

SCALE 1/32"=1'-0"

WHITE. ANTIMICROBIAL, ELONGATED, OPEN FRONT SOLID PLASTIC TOILET SEAT WITH STAINLESS STEEL, SELF SUSTAINING & EXTERNAL CHECK HINGES. BEMIS #2155SSC CHROME PLATED BRASS LOOSE KEY STOP WITH FULL TURN BRASS STEM, WALL ESCUTCHEON, 1/2" INLET & 3/8" OUTLET; BRASSCRAFT #SCR19C. RIGID CHROME PLATED COPPER TOILET RISER TUBE W/ GASKET NOSEPIECE; BRASSCRAFT #1-12DL C

L-1 ADA,  $20-5/16 \times 14-3/16$  INCH, RECTANGLE, UNDERMOUNT, WHITE, VITREOUS CHINA, UNDER COUNTER LAVATORY WITH CONCEALED FRONT OVERFLOW. MANSFIELD "BRENTWOOD" #234 CHROME PLATED, CAST BRASS LAVATORY FAUCET WITH 4" CTRS, SINGLE ADA COMPLIANT HANDLE, CERAMIC CARTRIDGE, TEMPERATURE LIMIT STOP AND NON-SPLASH VANDAL RESISTANT SPRAY OUTLET. MOEN COMMERCIAL #8430 SERIES FURNISH (2) CHROME PLATED BRASS LOOSE KEY STOPS WITH FULL TURN BRASS STEM, WALL ESCUTCHEON, 1/2" INLET & 3/8" OUTLET; BRASSCRAFT #SCR19C. RIGID CHROME PLATED COPPER FAUCET RISER TUBE W/ INSERT; BRASSCRAFT #1-12A C ASSE 1070 CERTIFIED, UNDER COUNTER THERMOSTATIC MIXING VALVE WITH SOLID BRASS BODY, STAINLESS STEEL INTERNAL COMPONENTS & STRAINER, 1/2" FNPT CONNECTIONS, INTEGRAL CHECKS AND VANDAL RESISTANT LOOKING NUT: MOEN COMMERCIAL #104451 WHITE, ADA-COMPLIANT, ANTIMICROBIAL, 1/8" THICK MOLDED VINYL UNDERSINK SAFETY COVERS WITH BUILT-IN FASTENERS, OFFSET TAILPIECE COVER, (2) ANGLE STOP COVERS & (2) SUPPLY COVERS: TRUEBRO "LAV GUARD 2" #103-E-Z FURNISH 1-1/2" CHROME PLATED TUBULAR BRASS P-TRAP ASSEMBLY WITH WALL ESCUTCHEON AND EXTENSION TUBE MFG'D BY DEARBORN BRASS.

SK-1 ADA COMPLIANT,  $28" \times 18" \times 5-1/2"$  DEEP, 18 GAUGE, TYPE 304STAINLESS STEEL, UNDERMOUNT SINK WITH UNDERCOATING, 3-1/2" STAINLESS STEEL CRUMB CUPS AND DRAIN, 1-1/2" CHROME PLATED CAST BRASS P-TRAP; BLANCO "STELLAR" #441559 ADA COMPLIANT, CHROME PLATED BRASS, DECK MOUNTED BAR SINK FAUCET ON 8" CENTERS WITH 1/4" TURN CERAMIC DISC CARTRIDGES, ADA COMPLIANT WRIST BLADE HANDLES, GOOSE-NECK SPOUT AND VANDAL RESISTANT NON-SPLASH AERATOR SPRAY OUTLET. MOEN COMMERCIAL #8287 FURNISH (2) CHROME PLATED BRASS LOOSE KEY STOPS WITH FULL TURN BRASS STEM, WALL ESCUTCHEON, 1/2" INLET & 3/8" OUTLET; BRASSCRAFT #SCR19C. RIGID CHROME PLATED COPPER FAUCET RISER TUBE W/ INSERT; BRASSCRAFT #1-12A C ASSE 1070 CERTIFIED, UNDER COUNTER THERMOSTATIC MIXING VALVE WITH SOLID BRASS BODY, STAINLESS STEEL INTERNAL COMPONENTS & STRAINER, 1/2" FNPT CONNECTIONS, INTEGRAL CHECKS AND VANDAL RESISTANT DOOKING DUT; MOEN COMMERCIAL #104451

MB-1 24" x 24" x 10" HIGH FLOOR MOUNTED, MOLDED STONE SERVICE BASIN WITH CHROME PLATED STRAINER, INTEGRAL MOLDED DRAIN WITH SEAL AND BUMPER GUARDS. E.L. MUSTEE "DURASTONE" #63M CHROME PLATED. CAST BRASS. WALL MOUNT. TWO HANDLE SERVICE SINK FAUCET WITH INTEGRAL VACUUM BREAKER, INTEGRAL CHECK STOPS TO ELIMINATE THERMAL CROSSOVER, PAIL HOOK, WALL BRACE AND THREADED HOSE END SPOUT. MOEN COMMERCIAL "M-DURA"

#### PLUMBING SYMBOLS NOT ALL SYMBOLS MAY APPLY ------ EXISTING COLD WATER PIPING — — — EXISTING UNDERGROUND SEWER

EXISTING SUSPENDED SEWER ---- EXISTING VENT PIPING 

———— – — HOT WATER PIPING (INSULATED) — — — UNDERGROUND SEWER SUSPENDED SEWER

PIPE CAPPED PIPE CONTINUATION \_\_\_\_\_ PIPE DROP (ELBOW)

---- VENT PIPING

——O

 $---\infty$ 

PIPE UP/RISER (ELBOW) P-TRAP 

PIPE DROP (TEE)

CLEANOUT PLUG (SIOUX CHIEF #875-2P/877/876) ı⊢ co WALL CLEANOUT PLUG (SIOUX CHIEF #870/873/877/876) ı⊢ wco

FLOOR CLEANOUT (SIOUX CHIEF #834) **⋘** FCO FLOOR DRAIN (FINISHED FLR AREA) (SIOUX CHIEF #832 OR 833)

 GV GATE VALVE (NIBCO OR EQUAL) BALL VALVE (NIBCO OR EQUAL)

CHECK VALVE (NIBCO OR EQUAL)

-D≪H BFP DUAL CHECK BACKFLOW PREVENTERS - USE WATTS #7 FOR ICE & COFFEE MAKERS - USE WATTS #9BD FOR CARBONATORS/SODA DISP. (S.S. W/ ATMOSPHERIC PORT)

NEW CONNECT TO EXISTING INDICATES SANITARY SEWER INDICATES EXISTING

## PLUMBING ENERGY NOTES

- 1.) PROVIDE HEAT TRAPS IN COMPLIANCE WITH IECC 404.3 ON CW SUPPLY TO WATER HEATER & HW OUTLET (HEAT TRAP NIPPLE, U-FLEX CONNECTOR & FABRICATED RETURN BEND).
- 2.) PROVIDE AUTOMATIC TIME SWITCHES TO TURN HOT WATER RECIRCULATION PUMPS OFF WHEN IT IS NOT IN USE. FOR AUTOMATIC-CIRCULATING HOT WATER SYSTEM. HWS AND HWR PIPING SHALL BE INSULATED PER IECC 404.4 W/ 1 OF INSULATION HAVING A CONDUCTIVITY NOT EXCEEDING 0.27 (BTU PER INCH/H x FT2 x F)
- .) PROVIDE AUTOMATIC VENT OR FLUE DAMPERS FOR ALL FUEL FIRED WATER HEATERS.
- 4.) ALL WATER HEATERS TO BE ENERGY EFFICIENT (STAND-BY HEAT LOSS & FUEL EFFICIENCY).
- 5.) INSULATE AT LEAST THE FIRST 8'-0" OF PIPE ON NON-CIRCULATED

								·						
	FIXTURE UNIT CALCULATIONS													
	FIXTURE TYPE	QTY.	C.W.S.F.U.	H.W.S.F.U.	T.H.W.S.F.U.	T.W.S.F.U.	TOTAL	D.F.U.	TOTAL					
	WATER CLOSET (TANK TYPE)	2	3			3	6	4	8					
7	LAVATORY	2	1.5	1.5	3	2	4	2	4					
	FLOOR DRAIN - (4")	2	-				-	6	12					
	BREAK ROOM SINK	1	1.5	1.5	1.5	2	2	2	2					
	DISHWASHER	1	-	1	1	1	1	2	2					
	MOP BASIN	1	2.25	2.25	2.25	3	3	3	3					
/	TOTALS	7			7.75		16		31					
		w/o fd's)		REQ'D CONN.	3/4"HW		3/4"CW		4" SAN					

COMMERCIAL WATER HEATERS.

#### PLUMBING NOTES

1.) ALL CLEANOUTS SHALL BE INSTALLED WHERE READILY ACCESSIBLE. THE CONTRACTOR SHALL COORDINATE ALL CLEANOUT LOCATIONS, WITH EQUIPMENT CABINETS, ETC. PROVIDE FULL SIZED CLEANOUTS ON STRAIGHT RUN INTERVALS NOT TO EXCEED FIFTY (50') AS WELL AS AT EACH CHANGE OF DIRECTION GREATER THAN (60 ). FIXTURE TRAPS (I.E. FLOOR DRAINS) SHALL NOT CONSTITUTE CLEANOUT ACCESS POINTS IF A CABLE MUST MAKE TWO (2) OR MORE RIGHT ANGLE TURNS IN ORDER TO ENTER THE MAIN DRAIN OR STACK.

SCALE 1"=1'-0"

- 2.) ALL PLUMBING FIXTURE VENTS SHALL TERMINATE A MINIMUM OF 12" FROM ANY VERTICAL SURFACE AND 12'-0" HORIZONTALLY FROM ANY OUTSIDE FRESH AIR INTAKE OR A MINIMUM OF 24" ABOVE FRESH AIR IN-TAKES IF THE 12'-0" HORIZONTAL SEPERATION IS NOT POSSIBLE.
- 3.) INSTALL FULL-PORT SHUT-OFF VALVES ON ALL HOT & COLD WATER SUPPLY LINES TO ALL FIXTURE OR APPLIANCE GROUPS/AREAS. ALL VALVES SHALL BE FULL LINE SIZED FOR THE BRANCH THEY SERVE. LOCATE VALVES IN AN ACCESSIBLE AREA OR PROVIDE ACCESS PANEL IN UNACCESSIBLE CEILING/WALL AREAS. ALL NEWLY INSTALLED BRASS SHUT-OFF VALVES FOR POTABLE WATER SHALL COMPLY WITH 1417 (a) 1 OF THE 2014 SWDA.
- 4.) PROVIDE 18" (MINIMUM) LONG AIR CHAMBERS ON ALL WATER SUPPLY LINES TO FIXTURES AND EQUIPMENT. PROVIDE WATER HAMMER
- ARRESTORS AT ALL FIXTURES WITH QUICK-CLOSING VALVES/FAUCETS. 5.) PROVIDE AIR GAPS FOR INDIRECT DRAINS AS REQUIRED BY CODE. AIR GAP SHALL BE 2 TIMES THE DIAMETER OF THE INDIRECT DRAIN.
- 6.) PROVIDE DI-ELECTRIC UNIONS, COUPLINGS, ADAPTORS OR FLANGES AT ALL TRANSITIONS OF FERROUS PIPING TO NON-FERROUS PIPING.
- 7.) PROVIDE NON-REMOVEABLE/INTEGRAL VACUUM BREAKER (@ 7'-6" A.F.F.) ON ALL NEW/EXIST. MOP BASIN FAUCETS & ALL OTHER NEW/EXISTING THREADED HOSE OUTLETS, HOSE BIBBS AND WALL HYDRANTS.
- 8.) COORDINATE ROUTING OF ALL PIPING SYSTEMS TO AVOID DUCTWORK, ELECTRICAL CONDUIT, BEAMS AND OTHER STUCTURAL MEMBERS.
- 9.) PROVIDE APPROVED BACKFLOW PREVENTION DEVICE ON ALL WATER SUPPLY LINES TO SODA DISPENSERS, COFFEE MAKERS, CAPPUCCINO MAKERS, CARBONATORS, ICE MACHINES, HUMIDIFIERS, BOILER MAKE-UP AND SANIITIZING CHEMICAL FEED CONNECTIONS. PER LOCAL CODE REQUIREMENTS & EQUIP./FIXTURE MFR'S REQUIREMENTS. LOCATE IN AN ACCESSIBLE AREA. COORDINATE ALL MAKE-UP/HUMIDIFIER CONNECTIONS W/ MECHANICAL CONTRACTOR.
- 10.) PROVIDE VALVE STEM EXTENSIONS AS REQUIRED FOR ALL INSULATED WATER SUPPLY PIPING.
- 11.) PROVIDE GROUTING/CAULKING WHERE FIXTURES MEET WALLS, FLOORS, COUNTRTOPS, ETC.
- 12.) PROVIDE ADA-COMPLIANT FLUSH VALVE HANDLES/TRIP LEVERS THAT ACTIVATE W/ 5 FOOT POUNDS OF PRESSURE OR LESS FORCE. LOCATE ALL WATER CLOSET FLUSH VALVE HANDLES/TRIP LEVERS ON WIDE SIDE OF
- 13.) ROUTE CIRCULATING HOT WATER DISTRIBUTION MAINS WITHIN 25 FEET (MINIMUM) OF EACH FIXTURE. PROVIDE CIRCUIT SETTER BALANCING/ COMPENSATING FLOW CONTROL VALVES FOR BALANCING CONTROL IN ACCESSIBLE LOCATIONS (PROVIDE ACCESS PANEL AS REQUIRED). INSULATE ALL RE-CIRCULATION PIPING PER ENERGY NOTE #2.
- 14.) ALL EXPOSED WASTE PIPING LOCATED IN TOILET ROOMS SHALL BE CHROME PLATED BRASS WITH MATCHING STOPS AND ESCUTHEONS. PROVIDE LOOSE KEY TYPE STOPS IN ALL PUBLIC AREAS OR WHERE VANDAL RESISTANT INSTALLATIONS ARE REQUIRED. ALL RISER TUBES SHALL BE RIGID CHROME PLATED COPPER.
- 15.) PROVIDE PROTECTIVE INSULATED PIPE COVERS ON P-TRAPS, ANGLE STOPS, OFFSET TAILPIECES, RISER SUPPLY TUBES, ETC. FOR ALL ADA ACCESSIBLE FIXTURES.
- 16.) PROVIDE A.S.S.E. 1070 APPROVED THERMOSTATIC MIXING VALVE TO SUPPLY 110 DEGREE (MAX) HOT WATER AT TIME OF INSTALL/INSPECTION TO ALL PUBLIC & ADA ACCESSIBLE LAVS/HAND SINKS. PROVIDE 110 DEGREE (MAX) HOT WATER TO ALL PUBLIC & ADA SHOWERS. PROVIDE 140 DEGREE HW TO ALL FIXTURES USED FOR SANITIZING/CLEANING.
- PROVIDE A VACUUM RELIEF VALVE ON ALL ELEVATED OR BOTTOM FED WATER HEATERS IN ADDITION TO A TEMPERATURE & PRESSURE RELIEF VALVE.
- /18.) OUTLET TEMPERATURE ON ALL WATER HEATERS SHALL BE SET AT 135 (MINIMUM) AND THERMOSTATICALLY MIXED DOWN AT POINTS INDICATED ON PLANS.
- 19.) ALL BACKFLOW PREVENTION DEVICES SHALL BE TESTED IN-LINE AND APPROVED BY A CROSS-CONNECTION CONTROL DEVICE INSPECTOR BEFORE BEING PLACED INTO SERVICE. BACKFLOW PREVENTERS SHALL BE TESTED AND MAINTAINED AT LEAST ANNUALLY BY A CROSS-CONN. CONTROL DEVICE INSPECTOR AND RECORDS TO VERIFY TESTING AND MAINTENANCE SHALL BE AVAILABLE AT THE SITE OF THE INSTALLATION OF THE DEVICE. BACKFLOW PREVENTERS SHALL NOT BE INSTALLED MORE THAN 5'-0" ABOVE THE FLOOR. PROVIDE A PROTECTIVE STRAINER UPSTREAM OF ALL BACKFLOW PREVETNERS UNLESS THE DEVICE CONTAINS A BUILT-IN STRAINER. ALL BFP'S SHALL BE INSTALLED BY A ILLINOIS LICENSED PLUMBER.
- 20.) PLUMBING CONTRACTOR TO COORDINATE EXACT SIZE AND LOCATION OF EACH FLUE/VENT FOR EACH GAS-FIRED WATER HEATER. COORDINATE WITH MECHANICAL CONTRACTOR AND VERIFY ADEQUATE CHASE/CHIMNEY SPACE WITH ARCHITECT PRIOR TO START OF CONSTRUCTION.
- 21.) FURNISH FIRE RATED PIPE SLEEVE OR FIRE CAULKING ON ALL PIPE PENETRATIONS THROUGH FIRE RATED WALLS/FLOORS.
- 22.) ALL THERMAL EXPANSION TANKS SHALL BE PROPERLY SIZED FOR THE WATER HEATER IT SERVES AND CHARGED TO THE INLET PRESSURE OF THE COLD WATER SUPPLY TO THE WATER HEATER. THE THERMAL EXPANSION TANK SHALL ALSO BE SIZED IN ACCORDANCE WITH THE WATER HEATER INPUT AND THE BTU/H RATING OF THE TEMPERATURE & PRESSURE RELIEF VALVE.
- 23.) PROVIDE APPROVED AIR GAP FITTING PROTECTION AT DISHWASHER DISCHARGE INTO SANITARY SYSTEM. PROVIDE PROPER BFP ON WATER SUPPLY IF CHEMICAL FEEDS ARE USED.
- 24.) PROVIDE SIOUX CHIEF "PRIME PERFECT" TRAP PRIMERS FOR ALL FLOOR DRAINS NOT RECEIVING DISCHARGE ON A REGULAR BASIS FROM WATER SUPPLIED FIXTURES OR EQUIPMENT.
- 25.) SAWCUT EXISTING FLOOR AND WALL CONSTRUCTION AS REQUIRED IN ORDER TO ACCOMODATE NEW WASTE, VENT AND WATER SUPPLY PIPING. PATCH ALL NEW WORK TO MATCH EXISTING CONSTRUCTION. DEMOLITION OF ALL PLUMBING WASTE LINES SHALL NOT RESULT IN DEAD ENDS GREATER THAN 10'-0" IN LENGTH AND ALL WATER SUPPLY PIPING DEAD ENDS SHALL NOT EXCEED 2'-0" IN LENGTH.
- 26.) PLUMBING CONTRACTOR TO VERIFY ALL EXISTING WASTE, VENT AND WATER SUPPLY PIPING WHERE NEW CONNECTIONS ARE TO BE MADE PRIOR TO BID. VERIFY EXACT SIZE, LOCATION, INVERT, CONDITION AND REQUIREMENTS IN FIELD. REPORT ANY MAJOR DISCREPENCIES TO ARCHITECT/ENGINEER IMMEDIATELY.

#### PLUMBING SPECIFICATIONS

SCALE 3"=1'-0"

THE PLUMBING SYSTEM SHALL BE INSTALLED IN ACCORDANCE WITH THE STATE OF ILLINOIS PLUMBING CODE 2014 AND ALL LOCAL CODES, AMMENDMENTS & ORDINANCES OF THE VILLAGE/CITY OF NORTHBROOK, IL THE PLUMBING CONTRACTOR IS RESPONSIBLE FOR REVIEWING ALL PLANS & SPECIFICATIONS TO DETERMINE THE EXACT SCOPE OF WORK. ALL EXISTING SITE CONDITIONS SHALL BE FIELD VERIFIED BY THE PLUMBING CONTRACTOR AS REQUIRED PRIOR TO PLUMBING BID. PLUMBING CONTRACTOR SHALL BE RESPONSIBLE FOR ANY AND ALL FAILURES TO RECOGNIZE REQUIRED PLUMBNG WORK AT HIS OWN

PLUMBING CONTRACTOR SHALL MAKE ALL REQUIRED CONNECTIONS AS INDICATED ON THE PLUMBING DRAWINGS.

CONTRACTOR SHALL CLEAN AND REMOVE ALL UNUSED MATERIAL AND CONSTRUCTION DEBRIS FROM JOB SITE AND CLEAN ALL PLUMBING FIXTURES, EQUIPMENT AND FLOOR DRAINS.

ALL PLUMBING WORK SHALL BE SUBJECT TO OWNER'S ACCEPTANCE AND APPROVAL UNDER THIS CONTRACT. ALL PLUMBING SYSTEMS SHALL BE INSTALLED IN A PROFESSIONAL MANNER. ALL PLUMBING SYSTEMS SHALL BE TESTED, CLEANED AND ADJUSTED PER CODE AND AS REQUIRED UPON COMPLETION OF WORK. COORDINATE THE INSTALLATION OF ALL PLUMBING SYSTEMS WITH OTHER TRADES TO MAINTAIN PROPER CLEARANCES AND UTILIZE/CONSOLIDATE PIPING TO COMMON PIPE RACKING SYSTEMS, ETC.

"THICK FIBER GLASS FOR ALL COLD WATER SUPPLY PIPING 1-1/2" DÍA. OR LESS. 1" THICK FIBER GLASS ALL CW PIPING 2" AND LARGER. PROVIDE PROPER MOLDED FITTINGS, JACKETS, VAPOR BARRIER & TAPE ALL JOINTS. INSULATE ALL ROOF DRAIN BODYS AND ALL HORIZONTAL STORM PIPING BACK TO DOWNSPOUT. PIPE COVERING TO BE SHALL BE 3 1/2 LB. DENSITY 1-1/2" THICK FIBER GLASS W/MOLDED FITTINGS, BUTT JOINTS & VAPOR BARRIER.

ALL PLUMBING EQUIPMENT START-UPS SHALL BE INCLUDED UNDER PLUMBING CONTRACT TO ENSURE PROPER OPERATION.

ALL WATER PIPING SHALL BE TESTED WITH WATER UNDER PRESSURE OF 100 PSI FOR 10 MINUTES. AND MADE TIGHT AT THIS PRESSURE.

ALL SOIL, WASTE AND VENT PIPING SHALL BE SUBJECTED TO A HYDROSTATIC TEST OF NOT LESS THAN 10 FEET OF WATER COLUMN FOR 15 MINUTES BEFORE INSPECTION STARTS AND PROVEN TIGHT. ALL DOMESTIC WATER SUPPLY PIPING SHALL BE CHLORINATED FOR A 24 HR PERIOD AND THEN FLUSHED PRIOR TO TURNING SYSTEM OVER TO BUILDING OWNER.

PIPING MATERIALS
ALL BELOW GROUND WASTE & VENT PIPING SHALL BE SERVICE WEIGHT CAST IRON OR SCHEDULE 40 PVC (ONLY WHERE LOCAL CODE PERMITS). 4" DIA. MIN FOR ALL UNDERGROUND WASTE PIPING. ALL BELOW GROUND WATER PIPING SHALL BE TYPE "K" COPPER AND ABOVE GROUND TYPE "L" COPPER (2" & SMALLER). WATER SUPPLY PIPING 3" & LARGER SHALL BE DUCTILE IRON. ALL VENT PIPING 2" AND SMALLER SHALL BE TYPE "M" COPPER. ALL VENT PIPING 3" AND LARGER SHALL BE SERVICE WEIGHT CAST IRON. (SCHEDULE 40 PVC IS ACCEPTABLE FOR ABOVE GROUND D.W.V. SYSTEMS IN NON-PLENUM CEILINGS ONLY AND IF ACCEPTABLE BY LOCAL CODES).

A (1) YEAR SERVICE CONTRACT FROM DATE OF ACCEPTANCE/COMPLETION OF WORK ON ALL PLUMBING EQUIPMENT INSTALLED SHALL BE INCLUDED IN THIS CONTRACT.

#### SPRINKLER SPECIFICATIONS

THE GENERAL CONDITIONS AND SUPPLEMENTAL GENERAL CONDITIONS ISSUED BY THE ARCHITECT SHALL GOVERN WHERE APPLICABLE.

THIS CONTRACTOR SHALL VERIFY EXISTING SITE CONDITIONS AT THE JOB SITE BEFORE SUBMITTING BID. FAILURE TO RECOGNIZE WORK REQUIRED SHALL BE AT THE EXPENSE OF THIS CONTRACTOR. NO CONSIDERATION SHALL BE GIVEN FOR ADDITIONAL COMPENSATION AFTER THE LETTING OF BIDS.

ENTIRE INSTALLATION SHALL BE PERFORMED IN A FIRST-CLASS WORKMANLIKE MANNER. THE COMPLETED SYSTEMS SHALL BE FULLY OPERATIONAL; ACCEPTANCE BY THE OWNER SHALL BE A CONDITION WITH OTHER TRADES IN ORDER TO AVOID INTERFERENCES, PRESERVE MAXIMUM HEADROOM AND AVOID OMISSIONS. PROVIDE PROPER STANDPIPE SYSEMS IN ALL STAIRWELLS AND A 2HR RATING (MINIMUM) ON FIRE PUMP/SPRINLKLER SERVICE ROOM.

CONTRACTOR TO MAKE ALL NECESSARY TAPS, AS CALLED FOR ON THE

THIS CONTRACTOR SHALL REMOVE ALL DEBRIS ON COMPLETION OF THE JOB AND CLEAN ALL FIXTURES.

IT SHALL BE THE RESPONSIBILITY OF THIS CONTRACTOR TO START-UP. ADJUST AND CHECK FOR PROPER OPERATION, ALL EQUIPMENT INSTALLED UNDER THIS CONTRACT THIS CONTRACTOR SHALL ALLOW IN HIS INITIAL BID THE COST OF SERVICE

ON ALL EQUIPMENT INSTALLED UNDER HIS CONTRACT FOR A PERIOD OF ONE (1) YEAR FROM DATE OF FINAL INSPECTION OF THE WORK. THIS CONTRACTOR SHALL SUBMIT TO THE ARCHITECT/ ENGINEER, OWNERS

INSURANCE UNDERWRITER, AND LOCAL FIRE DEPARTMENT FOR APPROVAL COMPLETE INSTALLATION AND DESIGN DRAWINGS SHOWING THE SPRINKLER SYSTEM LAYOUTS. THE LAYOUT SHALL INDICATE ALL OF THE SPRINKLER PIPING, SPRINKLER HEAD LOCATIONS AND DETAILS OF ANCHORS AND SUPPORTS AS REQUIRED. THE SPRINKLER SYSTEM SHALL BE LAID OUT TO ELIMINATE ALL CONFLICTS

MECHANICAL AND ELECTRICAL SYSTEMS AS THEY ARE SHOWN ON THE CONTRACT DRAWINGS. THE LAYOUT SHALL INDICATE COORDINATION BETWEEN SUCH ITEMS AS DUCTWORK, LIGHTS, STRUCTURAL MEMBERS, ETC. PIPE FOR ABOVE GRADE SHALL BE NEW SCHEDULE 40 FOR BRANCHES AND SCHEDULE 10 FOR MAINS,

BETWEEN THE SPRINKLER SYSTEM AND THE STRUCTURE INCLUDING THE

STANDARD WEIGHT STEEL DESIGNED FOR 175 LB. WORKING PRESSURE,

CONFORMING TO A.S.A. B36.10 MANUFACTURED IN THE U.S.

PROGRAM (I.E. FGG/BM/CZ SYSTEM COMPATIBLE PROGRAM).

SPRINKLER PIPING MATERIALS (SUBURBS) SPRINKLER PIPING SHALL BE BLAZEMASTER CPVC FIRE SPRINKLER PIPE/FITTINGS & EXTRUDED/MOLDED FROM CPVC COMPOUNDS MFG'D BY LUBRIZOL ADVANCED MATERIALS. THE PIPE/FITTING COMPOUNDS SHALL MEET CELL CLASS 23547/24447, RESPECTIVELY, AS DÉFINED BY ASTM D1784, & SHALL BE CERTIFIED BY NSF INTL. FOR USE W/ POTABLE WATER. BOTH PIPE/FITTING COMPOUNDS SHALL BE PRESS. RATED BY PLASTICS PIPE INSTITUTE (PPI). PIPE SHALL MEET OR EXCEED THE REQUIREMENTS OF ASTM F442 IN STD. DIMENSION RATIO (SDR)13.5. FITTINGS SHALL MEET OR EXCEED THE REQUIREMENTS OF ASTM F437 (SCHEDULE 80 THREADED), ASTM F438 (SCHEDULE 40 SOCKET) AND ASTM F439 (SCHEDULE 80 SOCKET). PIPE/FITTINGS SHALL BE LISTED BY "UL" FOR USE IN WET AUTOMATIC FIRE SPRINKLER SYSTEMS & SHALL BEAR THE LOGO OF THE LISTING AGENCY. SEE UL FIRE PROTECTION EQUIPMENT DIRECTORY, CATEGORIES VIWT AND HFYH. ANCILLARY PRODUCTS COMING INTO CONTACT WITH PIPE AND FITTINGS MUST BE CHEMICALLY COMPATIBLE AS DETERMINED BY CPVC PIPE & FITTINGS MFGR OR COMPOUND MFGR, AND THUS LISTED ON PIPE, FITTINGS OR COMPOUND MFGR'S CHEMICAL COMPATIBILITY

THE SPRINKLER RISERS, MAINS AND BRANCH PIPING SHALL BE SUPPORTED FROM THE BUILDING STRUCTURE, USING APPROVED TYPE STEEL HANGERS, BRACKETS, ANCHORS AND STUDS, OF SIZE AND NUMBER IN ACCORDANCE WITH N.F.P.A. #13.

THE SPRINKLER SYSTEM SHALL BE INSTALLED IN CONFORMANCE WITH PAMPHLET 13 OF THE NATIONAL FIRE PROTECTION ASSOCIATION AND ALL REQUIREMENTS OF THE LOCAL FIRE DEPARTMENT AND OWNER'S INSURANCE UNDERWRITER. ALL PIPING ABOVE GRADE SHALL BE HYDROSTATICALLY TESTED AT 200 PSIG FOR A TWO-HOUR PERIOD IN ACCORDANCE WITH N.F.P.A. #24.

CONTRACTOR IS RESPONSIBLE FOR MODIFYING/ADJUSTING EXISTING SPRINKLER LOCATIONS, TYPE AND ASSOCIATED BRANCH PIPING AS REQUIRED IN ORDER TO ACCOMODATE NEW CEILING LAY-OUT. CONTRACTOR IS RESPONSIBLE FOR SPACING, PIPE SIZE, OFFSETS, CLEARANCES, VALVES, ELBOWS, HANGERS, ALL ACCESSORIES AND QUANTITIES FOR ALL. THIS CONTRACTOR SHALL DESIGN AND INSTALL A COMPLETE SPRINKLER

SYSTEM PER NFPA AND LOCAL CODES AND FURNISH HYDRAULIC CALCULATIONS.



Mechanical, Electrical, Plumbing Engineering and Consulting T (630)936-4700 2625 Butterfield Rd, Suite 138 S Oak Brook, IL, 60523 www.trustedengineering.com I.P.D.F. # 184-005121 EXP. 04/30/2017

I hereby certify that these plans were prepared by me, or under my direct supervision and control, and to the best of my knowledge, comply with all applicable codes.



DRAWINGS SIGNED 02/16/17

Jason L. Dyer, P.E. Illinois Professional Engineer Registration Number: 062059110 License Expires: 11/30/2017

DATE

2017-02-16 REISSUED FOR PERMIT 2016-12-23 ISSUED FOR PERMIT

PROJECT NAME:

# @Properties

PROJECT NO. 201621

OWNER: @Properties

ADDRESS: 1314 Shermer Rd Northbrook, IL 60062

DRAWING TITLE:

PLUMBING NOTES, **SCHEDULES & DETAILS** 

DRAWING NO:

P.200